#### ADDRESS: 100 SUMMIT ST

Proposal: Construct addition, garage, and one-story porch; modify windows and door

Review Requested: Final Approval Owner: Kerri and Ryan Farragut

Applicant: Aubrie Lincks, Krieger and Associates Architects Inc.

History: 1860

Individual Designation: 8/2/1973 District Designation: None

Staff Contact: Alex Till, alexander.till@phila.gov

**OVERVIEW:** This application proposes to demolish a non-historic garage building at an individually designated property and construct a two-story detached garage with carport in its place. It also proposes to demolish a one-story rear shed addition and construct a larger one-story addition with a roof deck. It proposes to convert a window into a door on the north facade. Finally, it proposes remove a small, non-historic airlock and add a small, one-story porch at the east or rear facade of the main block.

The house was constructed c. 1860 in an elaborate Italianate style. A major two-story addition was added to the house in 1909, and other major alterations took place in 1922 and 1946. The one-story shed addition and other areas proposed for alteration appear to date to the first half of the twentieth century. The garage appears to be a later twentieth-century building, but there has been an outbuilding in the same place on the property since at least 1895. The garage will be significantly larger than the existing and also feature a second-floor studio space. The addition will be approximately twice as large as the existing and feature a roof deck. The modifications to the rear window and door and addition of a porch will alter the current appearance of this rear wall, but it appears to be already altered. The proposed designs will reflect the materials and architectural details of the historic budling. All proposed work is located at the rear of the lot but will be visible from the adjacent Prospect Avenue.

#### **SCOPE OF WORK:**

- Demolish existing garage and one-story rear addition
- Construct a two-story garage and one-story rear addition with roof deck.
- Modify an existing window and door and construct a one-story porch.
- Convert window to door.

#### STANDARDS FOR REVIEW:

The Secretary of the Interior's Standards for the Treatment of Historic Properties and Guidelines include:

- Standard 9: New additions, exterior alterations, or related new construction shall not
  destroy historic materials that characterize the property. The new work shall be
  differentiated from the old and shall be compatible with the massing, size, scale, and
  architectural features to protect the historic integrity of the property and its
  environment.
  - The proposed alterations and additions meet Standard 9. The areas of work involve altering later, non-character-defining features of the building. The proposed massing, size and scale are larger than the existing structures on the site, but are compatible with the massing, size, scale, and architectural features of the historic building.

- Standard 10: New additions and adjacent or related new construction will be undertaken in such a manner that, if removed in the future, the essential form and integrity of the historic property and its environment will be unimpaired.
  - The proposed addition and garage will be removable in the future without affecting the integrity of the historic building; therefore, the proposal meets Standard 10.

**STAFF RECOMMENDATION:** Approval, with the staff to review details, pursuant to Standards 9 and 10.

#### Images:

Figure 1: 1910 Philadelphia Atlas, G.W. Bromley. Historic maps indicate that there was an outbuilding on the site of the current garage, but it does not match the form and footprint of the existing building. Maps do not indicate the presence of a one-story shed addition at the rear before 1910.

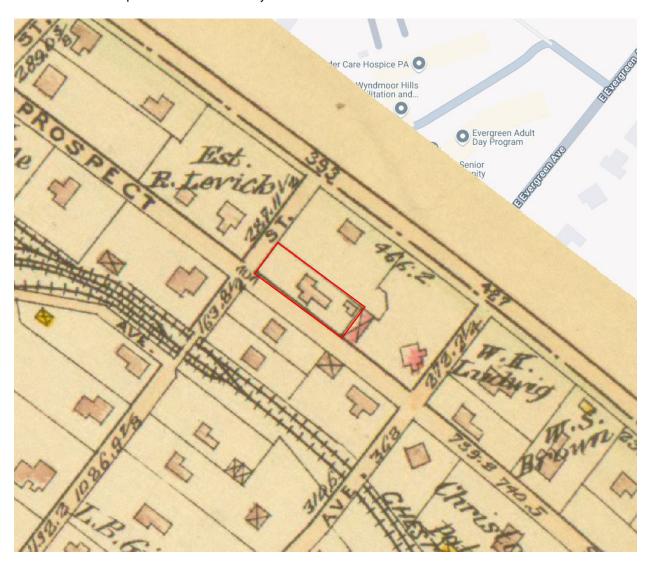


Figure 2: View of front of 100 Summit St from Summit St:



Figure 3: View of side of 100 Summit St from Prospect Ave. The new addition will be constructed in place of the small one-story addition at the right edge of this image.



Figure 4: Additional view of side/rear of 100 Summit St from Prospect Ave. The existing garage is located at the right edge of the image and indicated with an arrow. The one-story addition and area where the proposed modifications to the window and door are also indicated with arrows:



Figure 5: Aerial view of 100 Summit St, looking northwest, existing garage indicated with an arrow:



## Philadelphia Historical Commission Application 100 Summit St. | Philadelphia, PA 19118

January 10, 2024

Krieger + Associates Architects, Inc.

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Historic Photos 7-8

Architectural Drawings (see PDF)



14 West Highland Avenue Philadelphia, PA 19118 215.247.2020 kriegerarchitects.com

January 10, 2025

Philadelphia Historical Commission 1515 Arch Street Philadelphia, PA:

RE: 100 Summit Street

To whom it may concern:

Our clients Kerri & Ryan Farragut are the owners of the subject property which is listed in the City's Register of Historic Places. The proposed project scope includes the following:

- A 2-story detached garage with covered carport to replace the existing single-story garage and with artist's studio/workout room above
- First-floor interior renovations to existing kitchen.
- A single-story mudroom/rear entrance with deck above.
- Minor alterations to the main entrance.

Our design intent for the garage and addition is to harmonize with the existing Italianate villa, which has undergone multiple additions over the past one and a half centuries, in a multitude of architectural styles. Please refer to existing photos and the attached architectural drawings. The work may be phased, with the kitchen and mudroom addition preceding the garage.

Sincerely,

Aubrie Lincks

Staff Architect, Krieger + Associates Architects Inc.

autie Jende

## **Existing Site Photos**



100 Summit St. [2025.01.08]



100 Summit St. [2025.01.08]



### **Historic Photos**



Chestnut Hill Conservancy [1968]



Chestnut Hill Conservancy [1968]



Chestnut Hill Conservancy [1994]



Chestnut Hill Conservancy [1968]



Chestnut Hill Conservancy [1994]



Chestnut Hill Conservancy [1994]



Chestnut Hill Conservancy [1994]



Chestnut Hill Conservancy [1995]



Chestnut Hill Conservancy [2003]

# FARRAGUT RESIDENCE

100 Summit Street, Philadelphia, PA, USA

OWNER

# Ryan & Kerri Farragut

100 Summit Street Philadelphia, PA

**ARCHITECT** 

# KRIEGER + ASSOCIATES ARCHITECTS


14 WEST HIGHLAND AVENUE PHILADELPHIA, PA 19118

DOOR TYPE

ROOM NAME AND/OR

EXTERIOR ELEVATION

BUILDING/WALL SECTION

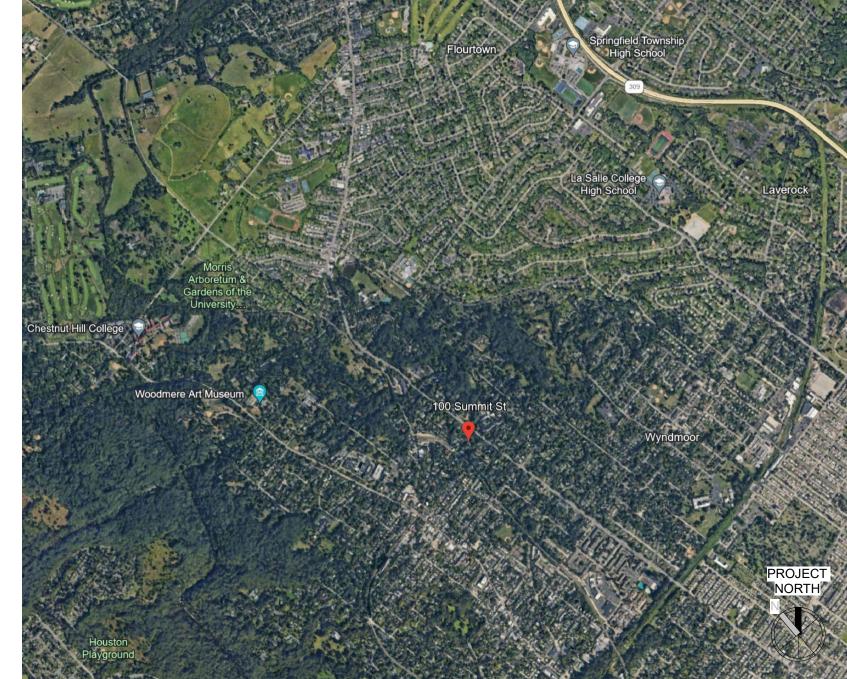

SITE LOCATION MAP


## **GENERAL DRAWING NOTES**

- IN CASE OF CONFLICT BETWEEN DRAWINGS AND SPECIFICATIONS, THE MORE
- AND/OR DEVIATIONS FROM DRAWINGS. PROPOSED REMEDIES, IF REQUIRING ADDITIONAL WORK, ARE TO BE SUBMITTED FOR APPROVAL IN THE FORM OF WRITTEN CONTRACT BEFORE ORDERING MATERIAL OR COMMENCING WITH WORK.
- WRITTEN DIMENSIONS HAVE PRECEDENCE OVER SCALED DIMENSIONS. ITEMS NOT NOTED AS EXISTING ARE PROPOSED. DOORS AND WINDOWS NOT NUMBERED ON THE FLOOR PLANS OR ELEVATIONS ARE EXISTING TO REMAIN, UNLESS
- ALL DIMENSIONS TO EXISTING SURFACES ARE TO FINISH, UNLESS NOTED OTHERWISE.
- MECHANICAL, ELECTRICAL, PLUMBING AND FIRE PROTECTION SYSTEMS ARE INDICATED ON ARCHITECTURAL DRAWINGS FOR COORDINATION ONLY. THIS PROJECT HAS BEEN DESIGNED USING THE 2018 INTERNATIONAL RESIDENTIAL
- CODE (IRC), AND APPLICABLE LOCAL REGULATIONS.

## **SPECIAL INSPECTION NOTES**

- SPECIAL INSPECTIONS ARE REQUIRED BY THE INTERNATIONAL BUILDING CODE FOR THIS PROJECT. SEE STATEMENT OF SPECIAL INSPECTIONS SCHEDULE FOR A LIST OF THE REQUIRED INSPECTIONS, AND FREQUENCY BY WHICH INSPECTIONS ARE TO BE CONDUCTED.
- IT IS THE OWNER'S RESPONSIBILITY TO RETAIN THE SERVICES OF A THIRD-PARTY SPECIAL INSPECTOR TO PERFORM SPECIAL INSPECTIONS. THE INSPECTION AGENCY MAY NOT BE THE DESIGN ARCHITECT OR STRUCTURAL ENGINEER OF RECORD TO AVOID CONFLICTS OF INTEREST. THE SPECIAL INSPECTION AGENCY MUST BE IAS ACCREDITED AND PRE-QUALIFIED BY THE CITY OF PHILADELPHIA TO PERFORM THE REQUIRED INSPECTIONS.
- THE STRUCTURAL ENGINEER OF RECORD IS TO BE THE DESIGN PROFESSIONAL IN RESPONSIBLE CHARGE OF SPECIAL INSPECTIONS (DPRC-SI). THE DPRC-SI IS RESPONSIBLE FOR THE FOLLOWING:
  - IDENTIFYING REQUIRED SPECIAL INSPECTIONS
  - SUBMITTING STATEMENT OF SPECIAL INSPECTIONS
  - EVALUATING AND SELECTING A SPECIAL INSPECTIONS AGENCY REPORTING NON-COMPLIANCE ISSUES TO THE CONTRACTOR AND TO L&I FOR
  - ISSUES THAT ARE HAZARDOUS TO LIFE, SAFETY OR HEALTH. REVIEWING AND APPROVING SPECIAL INSPECTIONS PROGRESS REPORTS AND FINAL REPORTS.
- IT IS THE CONTRACTOR'S RESPONSIBILITY TO SCHEDULE SPECIAL INSPECTIONS, AND TO MAINTAIN CONTRACT DOCUMENTS ON-SITE FOR USE BY THE SPECIAL INSPECTOR. 48 HOURS NOTICE IS REQUIRED FOR FIELD INSPECTIONS, AND 7 DAYS NOTICE IS REQUIRED
- A PRE-CONSTRUCTION MEETING IS RECOMMENDED TO DISCUSS SPECIAL INSPECTIONS. OWNER, DPRC-SI, ARCHITECT AND SPECIAL INSPECTOR TO ATTEND.

## MATERIAL LEGEND

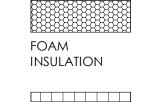



**ROUGH WOOD** 

SHEATHING

VENT SPACE /



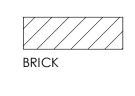


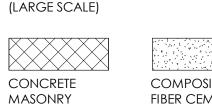







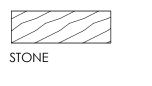



# SYMBOL LEGEND


Room name











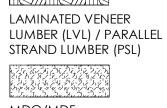




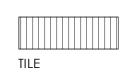



BLOCKING

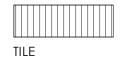



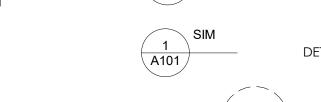

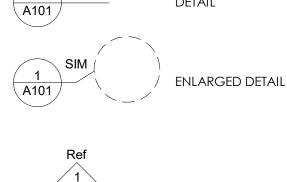

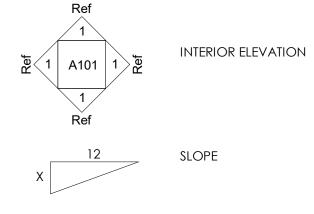

Name

Elevation



VERTICAL ELEVATION

## **ABBREVIATIONS**

EXG

EXP

EXT

COOLER

**EXISTING** 

EXTERIOR

**EXPANSION** 

FLOOR DRAIN

FOUNDATION

ACI	CEILING TILE		(CABINET)
ADDN	ADDITIONAL	FEN	FENCE
ADJ	ADJACENT	FF	FILTER FABRIC
ADJUST		FG	FIBERGLASS
AFF	ABOVE FINISH	FIN	FINISH
,	FLOOR	FLR	FLOOR
AL	ALUMINUM	FLUOR	FLUORESCENT
ALT	ALTERNATE	FP	FIREPLACE
AP	ACCESS PANEL	FT	FOOT
APP	APPLIANCE	FTG	FOOTING
APPROX	APPROXIMATE	FX	FIXED
AWN	AWNING	GA	GAUGE
B/O	воттом оғ	GALV	GALVANIZED
BC	BRICK COURSE(S)	GC	GENERAL
BD	BOARD		CONTRACTOR
BDBD	BEAD BOARD	GWB	GYPSUM WALL
ВМ	BEAM		BOARD
BOD	BASIS OF DESIGN	Н	HIGH
BR	BRUSHED	НВ	HOSEBIB
BSMT	BASEMENT	HDWD	HARDWOOD
CANT	CANTILEVER(ED)	HM	HOLLOW METAL
CBB	CEMENTITIOUS	HOP	HOPPER
	BACKER BOARD	HORIZ	HORIZONTAL
CBNT	CABINET	HT	HEIGHT
CI	CASTIRON	HTR	HEATER
CJ	CONTROL JOINT	INCAN	INCANDESCENT
CL	CENTER LINE	INSUL	INSULATION
CLNG	CEILING	INT	INTERIOR
CLR	CLEAR	JT '	JOINT
CMU	CONCRETE MASONRY UNIT	L	LOW
COL	COLUMN	LIN	LINOLEUM LOOKING
COL COMP	COMPOSITE	lkg lt	LIGHT
CONC	CONCRETE	LV	LOW VOLTAGE
CONC	CONTINUOUS	LVL	LAMINATED
CONTR	CONTRACTOR	LVL	VENEER LUMBER
CPT	CARPET	MATL	MATERIAL
CSMT	CASEMENT	MAX	MAXIMUM
CT	CERAMIC TILE	MDO	MEDIUM DENSITY
DBL	DOUBLE		OVERLAY
DED	DEDICATED	MFGR	MAUFACTURER
DEMO	DEMOLITION	MIN	MINIMUM
DH	DOUBLE HUNG	MO	MASONRY
DIA	DIAMETER		OPENING
DIMS	DIMENSIONS	MTD	MOUNTED
DN	DOWN	MTL	METAL
DS	DOWNSPOUT	NA	NOT APPLICABLE
DTL(S)	DETAIL(S)	NIC	NOTIN
DWG(S)	DRAWING(S)	N ITO	CONTRACT
EA	EACH	NTS	NOT TO SCALE
EJ	EXPANSION	O/A	OVERALL
	JOINT	O/C	ON CENTER
ELEC	ELECTRIC	OH	OVERHEAD
ENG	ENGINEERED	OPER	OPERABLE
EQ	EQUAL,	OPNG OPR	OPENING
	EQUIVALENT	OPP	OPPOSITE
FW/C	ELECTRIC WATER	PAF	POWDER

ACTUATED

**FASTENER** 

LAMINATE

PLASTIC

PLASTER

PLYWD PLYWOOD

PLAM

	STRAND LUMBER
PT	PRESSURE
	TREATED
R	RISER
RAD	RADIUS
RAG	RETURN AIR GRILL
RCP	REFLECTED
	CEILING PLAN
RECP	RECEPTACLE
RFF	REFRIGERATOR
REQD	REQUIRED
RES	RESILIENT
RO	ROUGH
KO	OPENING
S&R	SHELF & ROD
SAG	SUPPLY AIR GRILL
SC	SOLID CORE
	SCHEDULE
SCR	SCREEN
SECT	SECTION
SH	SINGLE HUNG
SIM	SIMILAR
SL	SLIDER
SSTL	STAINLESS STEEL
ST	STUCCO
STD	STANDARD
STL	STEEL
STN	STONE
STR	STRUCTURAL
T	TREAD
T&G	TONGUE &
	GROOVE
T/O	TOP OF
TBD	TO BE
	DETERMINED
TE	TEMPERED
TYP	TYPICAL
U/C	UNDER CABINET
U/S	UNDERSIDE
UNF	UNFINISHED
UNO	UNLES NOTED
UNO	OTHERWISE
VCB	VINYL COVE
٧СБ	BASE
VCT	VINYL
V C1	COMPOSITION
	TILE
VERT	VERTICAL
VIF	VERIFY IN FIELD
VTR	VENT THRU ROOF
W/	WITH
WD	WOOD
WDW	WINDOW
WG	WIRE GLASS
WH	WATER HEATER
WP	WALL PAPER
WWF	WELDED WIRE
	FABRIC

	SHEET LIST			
SHEET NUMBER	SHEET NAME	PRELIMINARY PRICING SET   03.28.24	ISSUE FOR ZONING PERMIT   08.13.24	PHC APPLICATION   01.10.25
0-Genero	ı			
G0.1	COVER SHEET	•	•	•
G0.2	PRELIMINARY PRICING SCHEDULE	•		
Z0.1	SITE PLAN	•	•	•
1-Archite	cture			
A1.1	DEMOLITION PLANS & SCHEDULES	•		•
A2.1	DEMOLITION PLANS & SCHEDULES FIRST FLOOR PLAN	•	•	•
A2.1 A2.2	DEMOLITION PLANS & SCHEDULES FIRST FLOOR PLAN SECOND FLOOR PLAN	•	•	•
A2.1 A2.2 A3.1	DEMOLITION PLANS & SCHEDULES FIRST FLOOR PLAN SECOND FLOOR PLAN EXTERIOR ELEVATION - ADDITION	•	•	•
A2.1 A2.2 A3.1 A3.2	DEMOLITION PLANS & SCHEDULES FIRST FLOOR PLAN SECOND FLOOR PLAN EXTERIOR ELEVATION - ADDITION EXTERIOR ELEVATION - ADDITION		_	•
A2.1 A2.2 A3.1	DEMOLITION PLANS & SCHEDULES FIRST FLOOR PLAN SECOND FLOOR PLAN EXTERIOR ELEVATION - ADDITION	•	•	•
A2.1 A2.2 A3.1 A3.2 A3.3 A3.4	DEMOLITION PLANS & SCHEDULES FIRST FLOOR PLAN SECOND FLOOR PLAN EXTERIOR ELEVATION - ADDITION EXTERIOR ELEVATION - ADDITION EXTERIOR ELEVATION - ADDITION EXTERIOR ELEVATION - GARAGE	•	•	•
A2.1 A2.2 A3.1 A3.2 A3.3 A3.4 A3.5	DEMOLITION PLANS & SCHEDULES FIRST FLOOR PLAN SECOND FLOOR PLAN EXTERIOR ELEVATION - ADDITION EXTERIOR ELEVATION - ADDITION EXTERIOR ELEVATION - ADDITION EXTERIOR ELEVATION - GARAGE EXTERIOR ELEVATION - GARAGE	•	•	•
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A3.7 EXTERIOR ELEVATION - GARAGE


A3.8 BUILDING SECTION - GARAGE

Krieger

ARCHITECT PROJECT NUMBER: ISSUE DATE:


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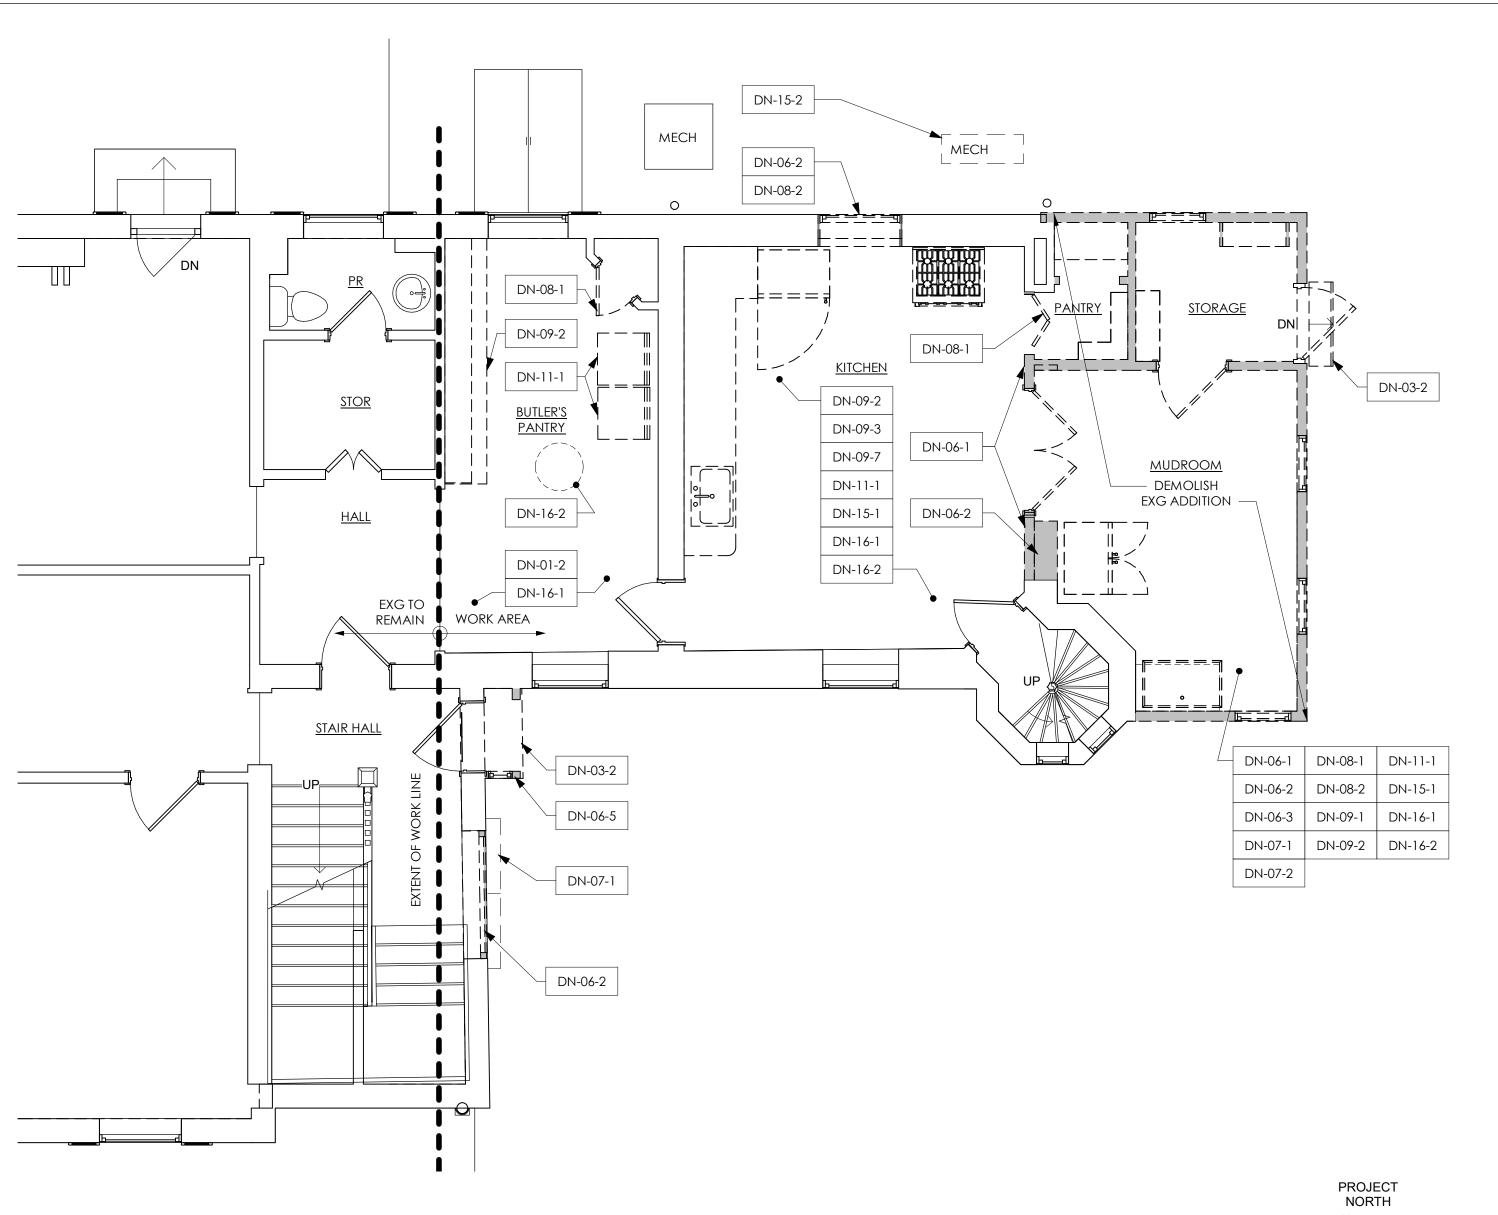
PHC APPLICATION

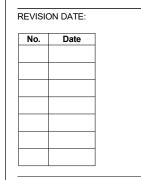


SHEET TITLE: **COVER SHEET** 

SHEET NUMBER:



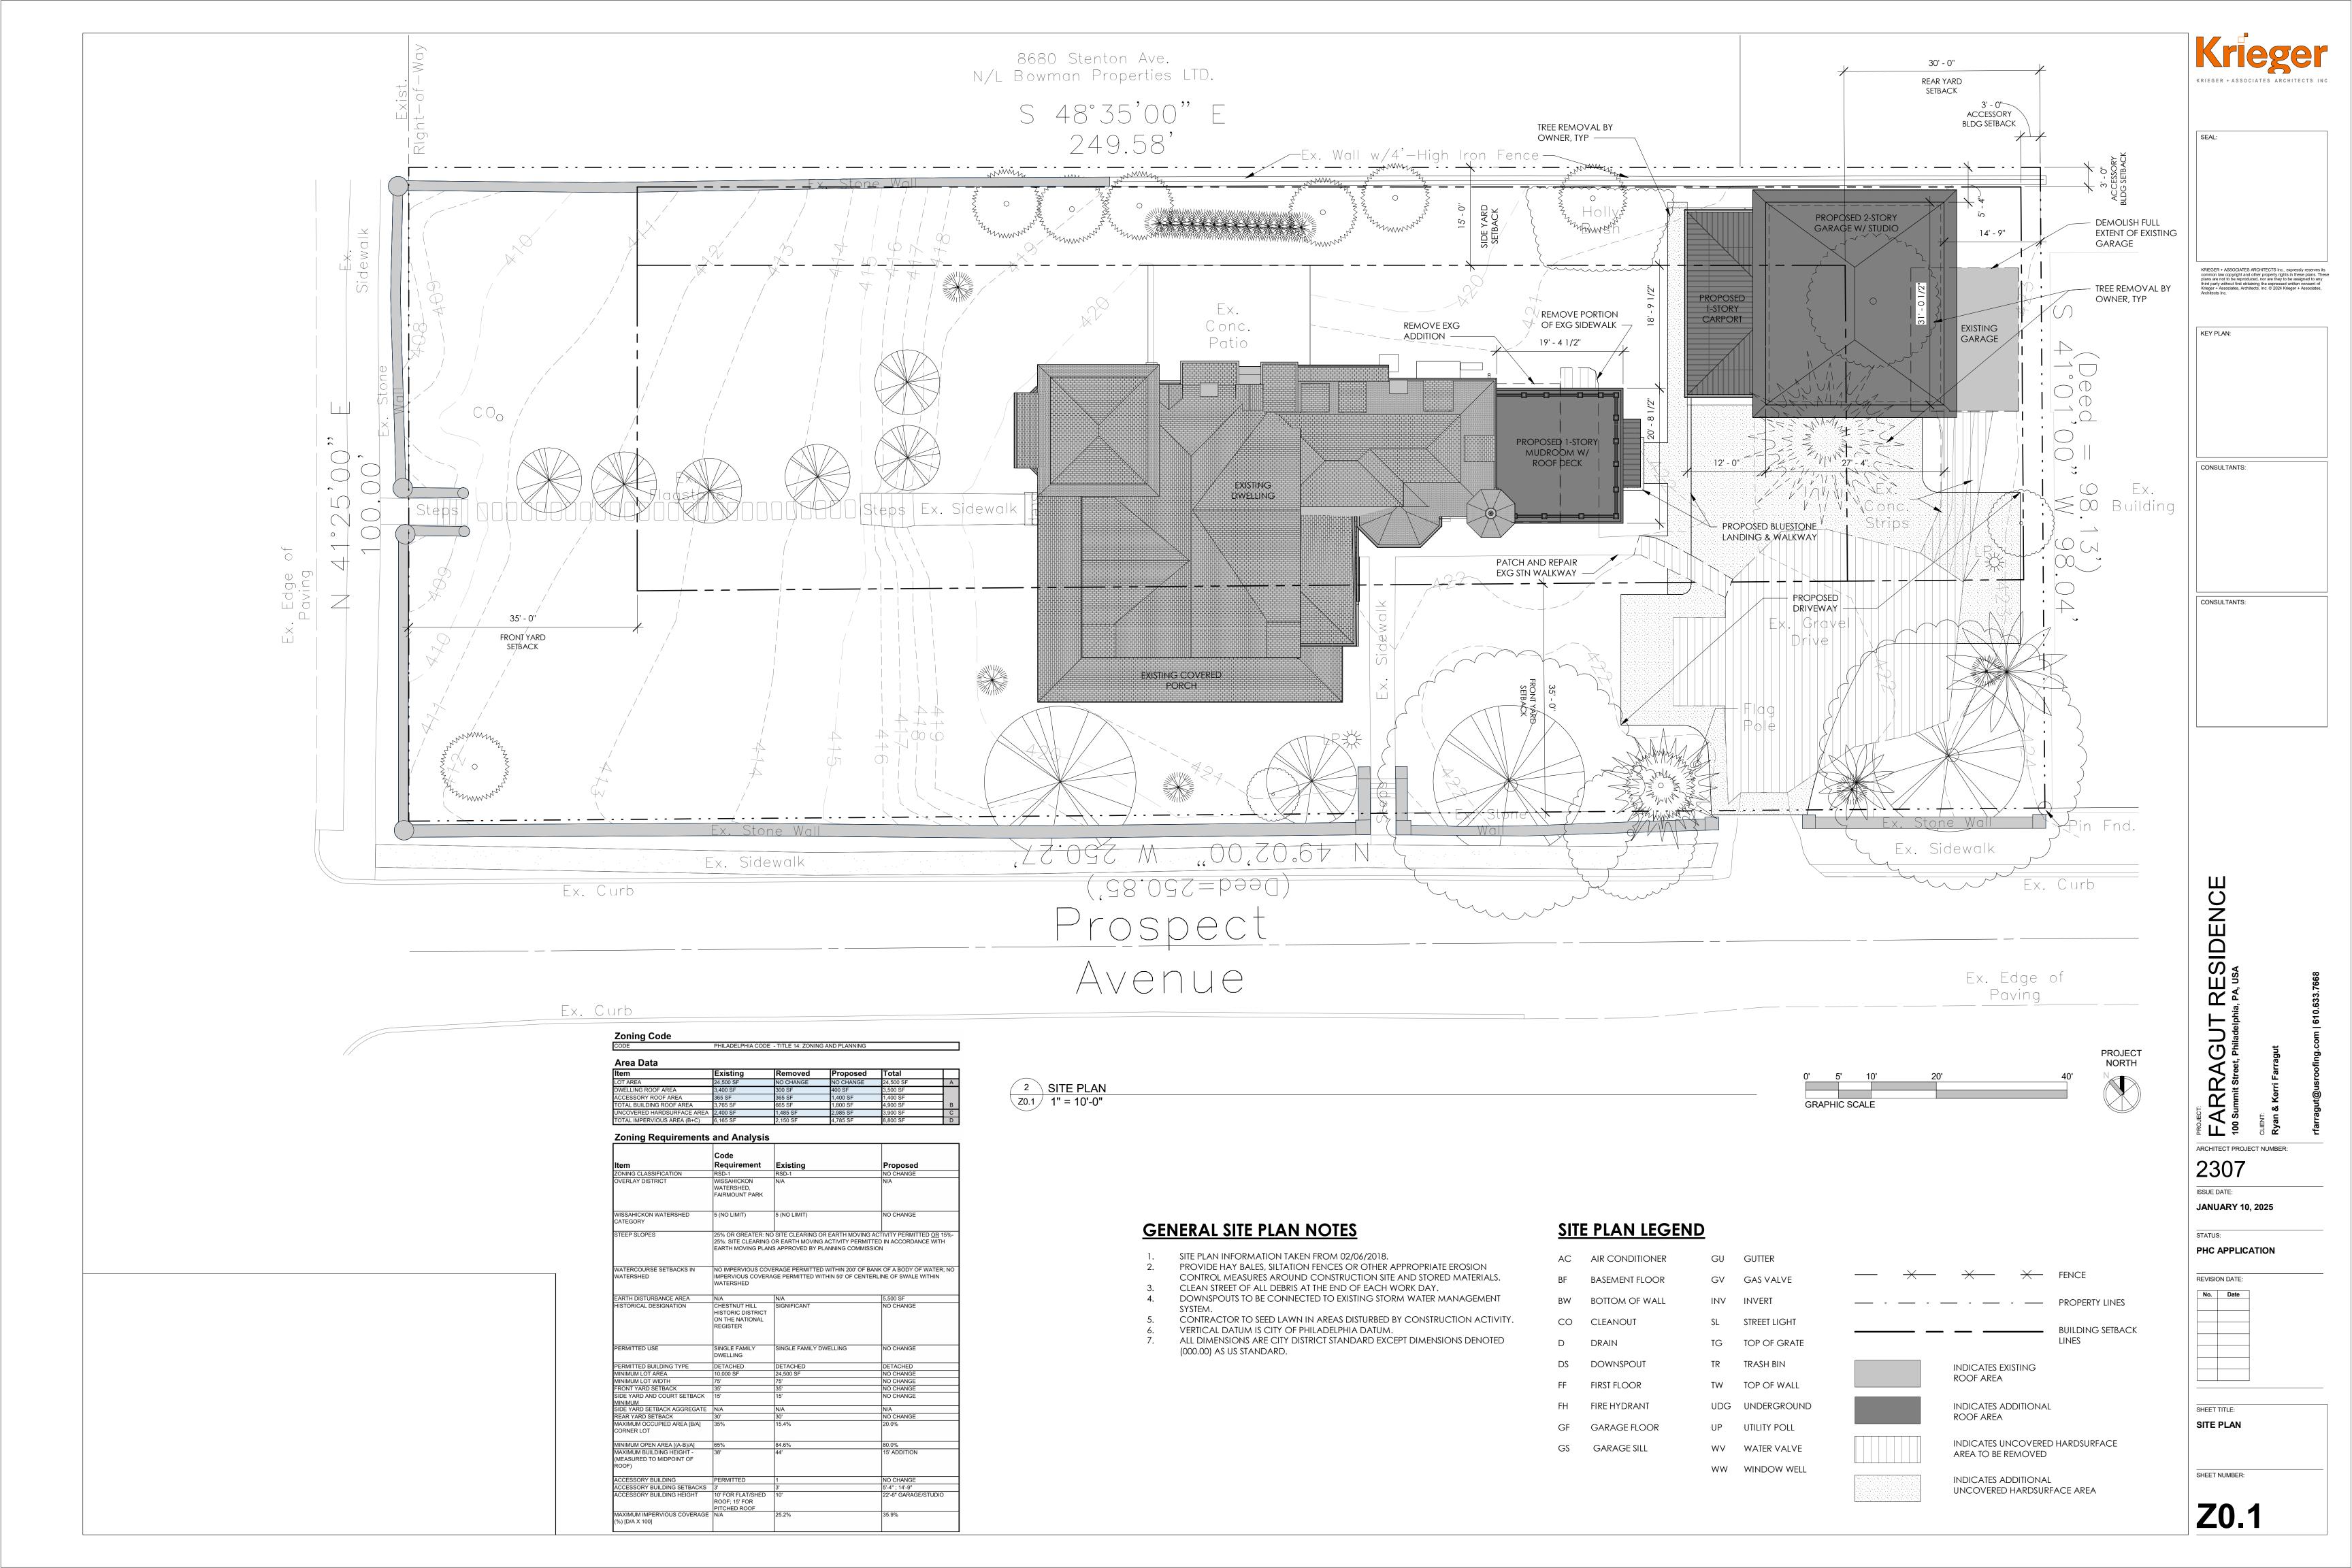

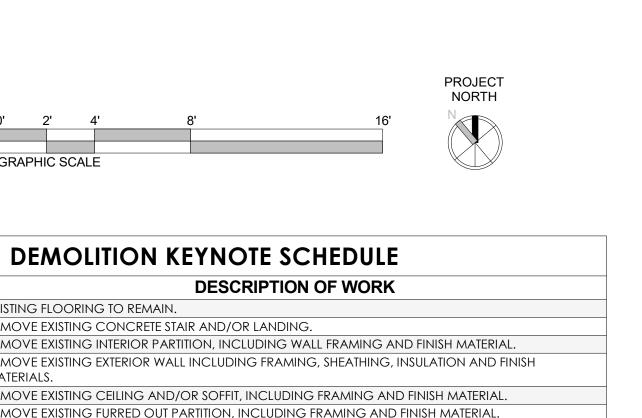

## \_\_\_\_ EXISTING ITEM TO BE DEMOLISHED

EXISTING WALL TO REMAIN

**DEMOLITION PLAN LEGEND** 

FIRST FLOOR DEMOLITION

1 PLAN - PHASE A


A1.1 1/4" = 1'-0"

EXISTING WALL TO BE DEMOLISHED

## **GENERAL DEMOLITION NOTES**

- 1. SEE FLOOR PLAN FOR DIMENSIONS AND DETAILS OF PROPOSED OPENINGS IN EXISTING BUILDING.
- SALVAGE EXISTING DOORS FOR RE-USE, UNO.
   DEMOLITION WORK BY GC, UNO.
- 4. ASSESS THE EXISTING MECHANICAL AND ELECTRICAL SYSTEMS TO VERIFY THAT EXISTING IS ADEQUATE TO SUPPORT PROPOSED WORK.
- 5. DEMOLITION PERMIT SET IS FOR NON-STRUCTURAL DEMOLITION ONLY.

<b>KEYNOTE NUMBER</b>	DESCRIPTION OF WORK
DN-01-2	EXISTING FLOORING TO REMAIN.
DN-03-2	REMOVE EXISTING CONCRETE STAIR AND/OR LANDING.
DN-06-1	REMOVE EXISTING INTERIOR PARTITION, INCLUDING WALL FRAMING AND FINISH MATERIAL.
DN-06-2	REMOVE EXISTING EXTERIOR WALL INCLUDING FRAMING, SHEATHING, INSULATION AND FINISH MATERIALS.
DN-06-3	REMOVE EXISTING CEILING AND/OR SOFFIT, INCLUDING FRAMING AND FINISH MATERIAL.
DN-06-4	REMOVE EXISTING FURRED OUT PARTITION, INCLUDING FRAMING AND FINISH MATERIAL.
DN-06-5	REMOVE EXISTING ENTRY SURROUND, WINDOW, SOFFIT, AND ROOF.
DN-07-1	REMOVE EXISTING FINISH ROOFING MATERIAL, INCLUDING UNDERLAYMENT AND RELATED ROOF FLASHING.
DN-07-2	REMOVE EXISTING GUTTERS AND DOWNSPOUTS, INCLUDING ALL HANGERS AND ACCESSORIES.
DN-08-1	REMOVE DOOR, FRAME, AND HARDWARE. SEE GENERAL DEMOLITION NOTES FOR ADDITIONAL INFORMATION.
DN-08-2	REMOVE WINDOW AND FRAME. SALVAGE FOR REUSE.
DN-09-1	REMOVE EXISTING FLOOR FINISHES AND SUBFLOOR.
DN-09-2	REMOVE EXISTING CABINETRY/CASEWORK.
DN-09-3	REMOVE EXISTING WALL TILE. SALVAGE FOR REUSE.
DN-09-4	REMOVE EXISTING WOOD WAINSCOT. SALVAGE FOR REUSE.
DN-09-5	RETAIN HARDWOOD FLOORING AT UPPER LEVEL PRIMARY BATHROOM. PATCH AND REFINISH; PREP FLOOR TO RECEIVE SALVAGED AND PROPOSED MARBLE INSERTS BENEATH TOILET AND TUB.
DN-09-6	REMOVE EXISTING MARBLE/STN FLOOR INSERTS. SALVAGE FOR REUSE.
DN-09-7	REMOVE EXISTING FLOOR FINISHES AND PREP SUBFLOOR FOR PROPOSED WORK.
DN-11-1	REMOVE EXISTING APPLIANCE(S) AND SALVAGE FOR REUSE.
DN-15-1	REMOVE EXISTING PLUMBING FIXTURE AND/OR FAUCET. SALVAGE FOR REUSE.
DN-15-2	REMOVE AND RELOCATE EXISTING MECHANICAL EQUIPMENT AS REQUIRED FOR PROPOSED WORK.
DN-16-1	REMOVE EXISTING ELECTRICAL DEVICES, SWITCHES, AND OUTLETS.
DN-16-2	REMOVE EXISTING LIGHTING FIXTURES AND SALVAGE FOR REUSE.

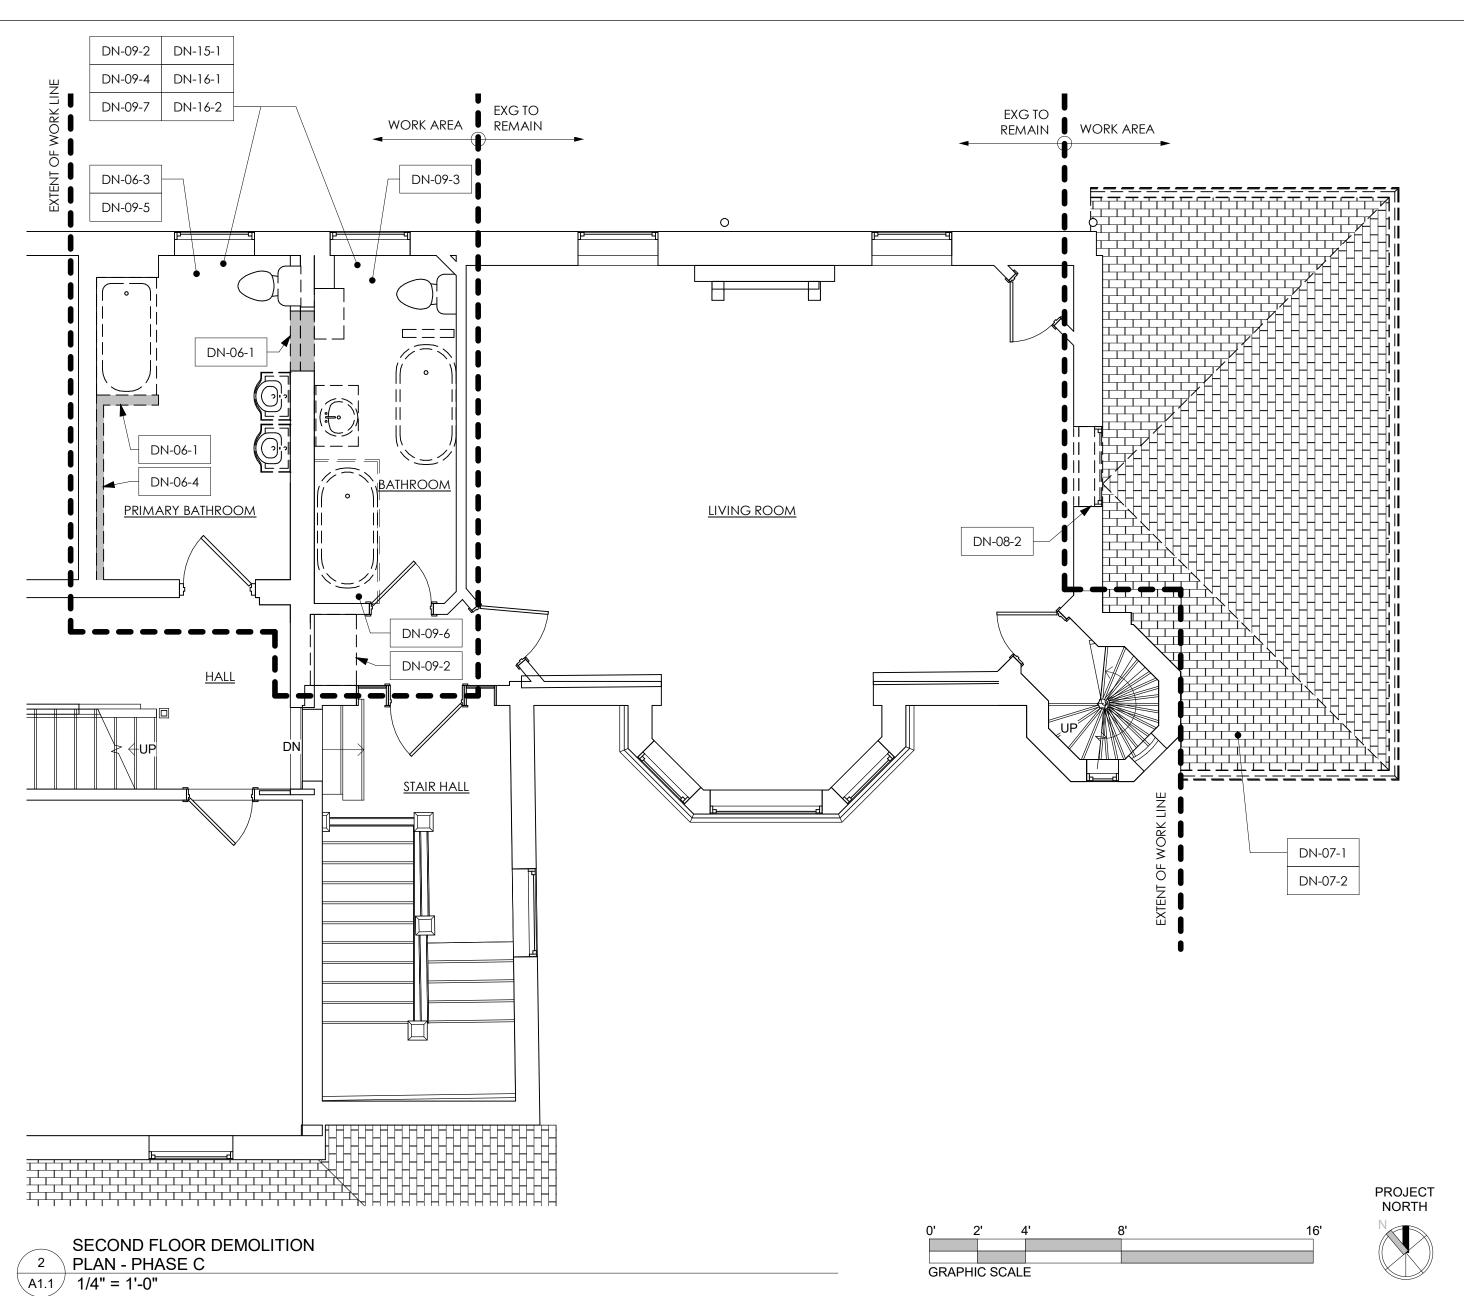

Work By Owner Schedule

ITEMS TO BE PURCHASED, DELIVERED AND INSTALLED BY OWNER UNO; CONTRACTOR TO COORDINATE SCHEDULE WITH OWNER THE FOLLOWING ITEMS ARE THE RESPONSIBILITY OF THE OWNER AND ARE NOT IN THE CONTRACT SUM: Description LANDSCAPING (AND ON-SITE STORM WATER MANAGEMENT LANDSCAPING (AND ON-SITE STORM WATER MANAGEMENT SYSTEM) TO BE PURCHASED AND INSTALLED BY OWNER. ROOFING (EXCLUDING SHEATHING) PROPOSED ROOFING, EXCLUDING SHEATHING, TO BE PURCHASED AND INSTALLED BY OWNER. APPLIANCES APPLIANCES TO BE PURCHASED AND INSTALLED BY OWNER. CABINETRY CABINETS TO BE PURCHASED BY OWNER AND INSTALLED BY CONTRACTOR OR OTHERS. SECURITY SYSTEM CONTRACTOR TO COORDINATE INSTALLATION BY OTHERS. CABLE/SATELITE DISH/DATA WIRING CABLE/SATELLITE DISH/DATA WIRING TO BE PURCHASED AND INSTALLED BY OWNER. AUDIO/VISUAL SYSTEM AUDIO/VISUAL SYSTEM, INCLUDING SPEAKERS AND WIRING, TO BE PURCHASED AND INSTALLED BY OWNER. WINDOW TREATMENTS BLINDS, DRAPES AND INTERIOR SHUTTERS TO BE PURCHASED AND INSTALLED BY OWNER. PRIMARY BATHROOM MIRROR PRIMARY BATHROOM MIRROR TO BE PROVIDED AND INSTALLED BY OWNER.

## Alternate Schedule

AN ALTERNATE IS AN AMOUNT PROPOSED BY BIDDER FOR CERTAIN WORK THAT MAY BE ADDED TO OR DEDUCTED FROM THE BASE BID AMOUNT IF OWNER ACCEPTS THE ALTERNATE. THE COST OR CREDIT FOR EACH ALTERNATE IS THE ADDITION TO OR DEDUCTION FROM CONTRACT SUM TO INCOPORATE THE ALETERNATE INTO THE WORK.

NO OTHER ADJUSTMENTS ARE MADE TO THE CONTRACT SUM.

INDICATE ON THE BID FORM AMOUNTS TO BE DEDUCTED FROM OR ADDED TO CONTRACT SUM FOR THE FOLLOWING ALTERNATES:

INDICATE ON THE BID FORM AMOUNTO TO BE DEDUCTED FROM ON ADDED TO CONTRACT COMPLETE TECHNICATES.	
Item	Description
ALTERNATE NUMBER 1	PROVIDE IN-FLOOR HEATING AT GARAGE SLAB
ALTERNATE NUMBER 2	PROVIDE NEW WINDOWS AT MUDROOM ADDITION
ALTERNATE NUMBER 3	PROVIDE @ GARAGE 1ST FLOOR WALLS: 8" CMU W/ 3-5/8" MTL STUD FURRING; FILL FURRING CAVITIES W/ 2LB HIGH DENSITY CLOSED-CELL SPRAY FOAM INSULATION (R-20 MIN) + 5/8" GWB WALL FINISH

RESIDENCE ia, PA, USA

KEY PLAN:

CONSULTANTS:

CONSULTANTS:

FARRAGUT R
100 Summit Street, Philadelphia, PA
CLIENT:
Ryan & Kerri Farragut

ARCHITECT PROJECT NUMBER: 2307

ISSUE DATE:

STATUS:

**JANUARY 10, 2025** 

PHC APPLICATION

REVISION DATE:

No. Date

SHEET TITLE:

DEMOLITION PLANS &
SCHEDULES

SHEET NUMBER:

A1.1

