ADDRESS: 252 QUINCE ST

Proposal: Legalize as-built roof and dormers

Review Requested: Final Approval

Owner: Danielle Harvey and Timothy Morrison

Applicant: Jonathan Wallace, AVLV Architecture & Development

History: 1806

Individual Designation: 2/28/1961

District Designation: Washington Square West Historic District, Contributing, 9/13/2024

Staff Contact: Allyson Mehley, allyson.mehley@phila.gov

OVERVIEW: This application proposes to legalize the as-built roof and dormers at 252 Quince Street, which deviate from the plans approved by the Historical Commission in December 2023. Deviations from the approved plans include the removal of original roof and framing, removal of front and rear cornices, construction of a roof above the location of the original roof, and installation of new dormers that differ in proportions from the approved dormers. This application for legalization was prompted by a staff site visit and subsequent issuance of a violation by the Department of Licenses and Inspections for construction that exceeded the approved plans.

SCOPE OF WORK:

Legalize aspects of as-built new construction that deviate from approved plans.

STANDARDS FOR REVIEW:

The Secretary of the Interior's Standards for the Treatment of Historic Properties and Guidelines include:

- Standard 9: New additions, exterior alterations, or related new construction shall not
 destroy historic materials that characterize the property. The new work shall be
 differentiated from the old and shall be compatible with the massing, size, scale, and
 architectural features to protect the historic integrity of the property and its environment.
 - The gable roof, which was constructed above the location of the historic roof, and dormers, which were constructed taller than approved, are incompatible with the historic property and environment and fail to satisfy Standard 9.
- Standard 10: New additions and adjacent or related new construction shall be undertaken in such a manner that if removed in the future, the essential form and integrity of the historic property and its environment would be unimpaired.
 - The historic integrity of the original 1806 roof and cornices was permanently altered with full removal, failing to satisfy this Standard 10.
- Roofs Guideline | Recommended: Designing rooftop additions, elevator or stair towers, decks or terraces, dormers, or skylights when required by a new or continuing use so that they are inconspicuous and minimally visible on the site and from the public right-of-way and do not damage or obscure character-defining historic features.
 - Front and rear dormers were constructed 10 inches taller than approved plans and the dormer cornices are oversized. As currently constructed, the dormers are highly visible from the public right-of-way and fail to satisfy the roof guideline.

STAFF RECOMMENDATION: Denial, pursuant to Standard 9, 10, and Roofs Guideline.

ADDITIONAL FIGURES:



Figure 1: 1958 photograph of 250 and 252 Quince Street.



Figure 2: 200 Block of Quince Street in August 2024 while under construction. 250- 258 252 Quince Street is second from right in the image.





Figure 4: Front façade of 252 Quince Street, December 2023.



Figure 5: Front façade of 252 Quince Street, August 2024.



Figure 6: Rear façade of 252 Quince Street as viewed from Manning Street, December 2023.



Figure 7: Rear façade of 252 Quince Street as viewed from Manning Street, August 2024.



Figure 8: Rear façade of 252 Quince Street as viewed from Manning Street, August 2024.

THE MINUTES OF THE 736TH STATED MEETING OF THE PHILADELPHIA HISTORICAL COMMISSION

FRIDAY, 8 DECEMBER 2023, 9:00 A.M. REMOTE MEETING ON ZOOM ROBERT THOMAS, CHAIR

CALL TO ORDER

START TIME IN ZOOM RECORDING: 00:00:00

Mr. Thomas, the Chair, called the meeting to order at 9:08 a.m. and announced the presence of a quorum. The following Commissioners joined him:

Commissioner	Present	Absent	Comment
Robert Thomas, AIA, Chair (Architectural Historian)	Χ		
Kimberly Washington, Esq., Vice Chair (Community Development Corporation)	X		
Donna Carney (Philadelphia City Planning Commission)	X		
Emily Cooperman, Ph.D., Committee on Historic Designation Chair (Historian)		Х	Arrived 9:53am
Erin Kindt (Department of Public Property)	X		
Sara Lepori (Commerce Department)	X		
John P. Lech (Department of Licenses & Inspections)	X		
John Mattioni, Esq.	X		
Dan McCoubrey, AIA, LEED AP BD+C, Architectural Committee Chair (Architect)	Х		
Stephanie Michel (Community Organization)		Χ	
Jessica Sánchez, Esq. (City Council President)	Χ		
Matthew Treat (Department of Planning and Development)	Χ		

The meeting was held remotely via Zoom video and audio-conferencing software.

The following staff members were present:

Jonathan Farnham, Executive Director

Kim Chantry, Historic Preservation Planner III

Mary Costello, Esq., Law Department

Laura DiPasquale, Historic Preservation Planner III

Heather Hendrickson, Historic Preservation Planner II

Ted Maust, Historic Preservation Planner II

Allyson Mehley, Historic Preservation Planner II

Leonard Reuter, Esq., Law Department

Dan Shachar-Krasnoff, Historic Preservation Planner II

Alex Till, Historic Preservation Planner II

The following persons attended the online meeting:

Abigail Hastings

A. Levine

Alex Balloon

Alexander Fidrych

- The design of the north elevation should be further explored as the wall plane currently appears flat and monotonous with minimal detailing. The applicant should consider additional masonry detailing, color variation, and window patterning to add more distinction to the north façade.
- The use of clapboard style cementitious siding on the south elevation should be reconsidered as this type of material is not appropriate for a building of this scale. Other materials should be explored such as a cementitious panelized system that is more compatible with larger scale buildings. The siding color should also be revisited as the dark color currently shown draws attention to this area of the building. Using a mix of materials on this elevation would break up the visual scale of the large south elevation wall.
- Elevator and stair overruns should be reduced to code-required height.

START TIME OF DISCUSSION IN ZOOM RECORDING: 03:31:53

PRESENTERS:

- Ms. Mehley presented the application to the Historical Commission.
- Architect Scott Shiffert represented the application.

PUBLIC COMMENT:

None.

HISTORICAL COMMISSION FINDINGS AND CONCLUSIONS:

The Historical Commission found that:

 The revised application includes updates made in response to the Architectural Committee's feedback. Revisions include brick and windows detailing, the addition of vertical reveals and lighter colored cladding on the south elevation, and reduced heights of the elevator overruns.

The Historical Commission concluded that:

- The overall design of the building relates to the Old City Historic District through its materials, massing, and proportions, satisfying Standard 9.
- As the lots are currently vacant, there would be no adverse impact on the surrounding buildings or on the historic district if this building were to be removed in the future, satisfying Standard 10.

ADDRESS: 252 QUINCE ST

Proposal: Construct dormer additions Review Requested: Final Approval

Owner: Danielle Harvey

Applicant: Jonathan Wallace, AVLV Architecture & Development

History: 1806, William Smith Individual Designation: 2/28/1961

District Designation: None

Staff Contact: Laura DiPasquale, laura.dipasquale@phila.gov

OVERVIEW: This application proposes to alter the gable roof of this circa 1810 rowhouse to create a livable fourth floor. The application originally proposed to install a wide dormer in the front roof slope and remove the rear roof slope to build an addition flush with the rear façade.

The Architectural Committee recommended denial of that application. Following the Architectural Committee meeting, the application was revised to address some of the Committee concerns, by pulling back the front dormer and creating a rear dormer, rather than addition, that leaves one foot of roof on either side and pulls the dormer two feet in from the rear façade. The revised application maintains the roof ridge.

SCOPE OF WORK:

- Remove rear slope of roof
- Construct fourth-floor rear addition
- Construct front dormer

STANDARDS FOR REVIEW:

The Secretary of the Interior's Standards for the Treatment of Historic Properties and Guidelines include:

- Standard 9: New additions, exterior alterations, or related new construction shall not
 destroy historic materials that characterize the property. The new work shall be
 differentiated from the old and shall be compatible with the massing, size, scale, and
 architectural features to protect the historic integrity of the property and its environment.
 - o The application proposes to remove the majority of the existing gable roof, a character-defining feature of the property, failing to satisfy Standard 9.
- Standard 10: New additions and adjacent or related new construction shall be undertaken in such a manner that if removed in the future, the essential form and integrity of the historic property and its environment would be unimpaired.
 - The application proposes to remove the rear slope of the roof for the installation of a new addition. If removed in the future, the essential form of the property would be altered, failing to satisfy this standard. Some portions of the rear gable should be preserved.
- Roofs Guideline | Recommended: Designing rooftop additions, elevator or stair towers, decks or terraces, dormers, or skylights when required by a new or continuing use so that they are inconspicuous and minimally visible on the site and from the public right-ofway and do not damage or obscure character-defining historic features.
 - If the front dormer is set back from the front façade and the rear addition is reconceived as a dormer, the dormers could be inconspicuous from the public rightof-way.

STAFF RECOMMENDATION: Approval, provided the front dormer is set back from the plane of the front façade and the rear addition is redesigned as a dormer that is set in from all sides to allow the original roof rafters and slope to remain visible, with the staff to review details, pursuant to Standards 9, 10 and the Roofs Guideline.

ARCHITECTURAL COMMITTEE RECOMMENDATION: Denial, pursuant to Standards 9, 10, and the Roofs Guideline.

START TIME OF DISCUSSION IN ZOOM RECORDING: 03:42:15

PRESENTERS:

- Ms. DiPasquale presented the application to the Historical Commission.
- Architect Jonathan Wallace represented the application.

PUBLIC COMMENT:

None.

HISTORICAL COMMISSION FINDINGS AND CONCLUSIONS:

The Historical Commission found that:

- The revised application addresses the Architectural Committee's concerns that the
 rear addition be reconceived as a dormer like the proposed front dormer, that the
 dormers be pulled in a minimum of 24 inches from the front and rear facades, that
 they tie into the existing roof ridge and retain roof rafters to either side of the
 dormers, that the boxiness of the dormers is reduced and flat trim boards used
 instead of siding on the front, and that the existing chimneys are retained.
- The application is similar to other dormers that the Historical Commission has approved on the block previously.

The Historical Commission concluded that:

- The proposed dormers retain the existing roof ridge and slope of the gabled roof and are pulled in from the front and rear facades, limiting removal of historic fabric, satisfying Standard 9.
- If the dormers were removed in the future, the essential form of the gable roof would remain, satisfying Standard 10.
- The dormers are set in from the front and rear facades and the views of the property are narrow, making the dormers inconspicuous from the public right-of-way, satisfying the Roofs Guideline.

ACTION: Mr. McCoubrey moved to approve the revised application, with the staff to review details, pursuant to Standards 9, 10, and the Roofs Guideline. Ms. Washington seconded the motion, which was adopted by unanimous consent.

ITEM: 252 QUINCE ST MOTION: Approval as revised MOVED BY: McCoubrey SECONDED BY: Washington					
		VOTE			
Commissioner	Yes	No	Abstain	Recuse	Absent
Thomas, Chair	Χ				
Washington, Vice Chair	X			_	
Carney (PCPC)	Χ				
Cooperman	Х				
Kindt (DPD)	Х				
Lepori (Commerce)	X				
Lech (L&I)	X				
Mattioni	X				
McCoubrey	Х				
Michel					X
Sánchez (Council)	X				
Treat (DPD)	Х				
Total	11				1

GENERAL FRAMING NOTES

- 1. ALL WORK TO BE IN COMPLIANCE WITH ALL APPLICABLE NATIONAL, STATE, & LOCAL BUILDING CODES.
- 2. CONTRACTOR(S) IS TO HAVE APPLICABLE LICENSE AND INSURANCE AS REQUIRED BY THE MUNICIPALITY.
- 3. CONTRACTOR(S) IS RESPONSIBLE FOR OBTAINING BUILDING PERMITS.
- 4. CONTRACTOR(S) IS RESPONSIBLE FOR CONTACTING THE BUILDING INSPECTOR FOR ANY / ALL REQUIRED INSPECTIONS FOR THE DURATION OF THE PROJECT.
- 5. CONTRACTOR(S) IS TO VERIFY EXISTING SITE CONDITIONS PRIOR TO COMMENCING WORK, NOTIFY ARCHITECT IMMEDIATELY REGARDING ANY DISCREPANCIES BETWEEN FIELD CONDITIONS AND ARCHITECTURAL DOCUMENTS.
- 6. THE ARCHITECT IS NOT RESPONSIBLE FOR THE CONTRACTOR(S) MEANS AND METHODS OF CONSTRUCTION.

WOOD FRAMING WALLS & FLOOR NOTES:

- 1. ALL JOISTS AND TIMBER FRAMING TO BE INSTALLED IN ACCORDANCE WITH THE AMERICAN INSTITUTE OF TIMBER CONSTRUCTION, FRAMING MATERIALS TO BE HEM FIR GRADE NUMBER 2 OR BETTER WITH A REPETITIVE MEMBER FIB 1,000 P.S.I. AND E=1,3000,000 P.S.I. ALL CONNECTIONS AND JOINTS ARE TO BE IN ACCORDANCE WITH THE AMERICAN INSTITUTE OF TIMBER CONSTRUCTION AND THE LOCAL BUILDING CODE AND ORDINANCES.
- 2 PLYWOOD SHEATHING TO BE EXTERIOR PLYWOOD APA EXTERIOR GRADE CDX. FLOOR, SHEATHING TO 3/4" PLYWOOD T&G WHERE REQUIRED. ROOF SHEATHING TO BE 5/8" PLYWOOD AND WALL SHEATHING 1/2"
 PLYWOOD U.N.O.
- 3. CONTRACTOR TO LAYOUT INTERIOR PARTITIONS & ALL ROUGH OPENINGS PRIOR TO ERECTING STUD WALLS TO COORDINATE DESIGN INTENT. NOTIFY ARCHITECT IMMEDIATELY UPON ANY DISCREPANCIES WITH ARCHITECTURAL FLOOR PLANS AND FIELD CONDITIONS. CONTRACTOR SHALL COORDINATE AND VERIFY CONDITIONS TO ENSURE PROPER FIT. CONTRACTOR IS RESPONSIBLE TO MAINTAIN CRITICAL DIMENSIONS AND CLEARANCES
- 4. ALL LOAD BEARING WOOD STUD WALLS ARE TO BE CAPPED WITH (2) 2x TOP PLATES INSTALLED TO PROVIDE OVERLAPPING AT CORNERS AND INTERSECTIONS WITH BEARING PARTITIONS.
- 5. CONTINUOUS SOLID 2x BRIDGING OR CROSS BRACING TO BE PROVIDED AT 1/2 SPAN OF ALL JOIST SPANS GREATER THAN 8'-0" IN LENGTH AS PER INDUSTRY STANDARDS U.N.O.
- 6. ALL WOOD BEAMS / HEADERS OVER 6"-0" IN LENGTH TO BE GLUED AND BOLTED W/ 1/2" CARRIAGE BOLTS GERED 1-1/2" (ABOVE & BELOW) NEUTRAL AXIS 32" O.C. (NO SPLICING BEAMS OR HEADERS
- 7. ALL WOOD CONTACTING MASONRY OR CONCRETE FOUNDATIONS IS TO BE PRESSURE TREATED /
- 8. NOTCHES IN SOLID LUMBER JOISTS, RAFTERS & BEAMS SHALL NOT EXCEED ONE-SIXTH OF THE DEPTH OF THE MEMBER SHALL NOT BE LONGER THAN ONE-THIRD OF THE DEPTH OF THE MEMBER AND SHALL NOT BE LOCATED IN THE MIDDLE ONE-THIRD OF THE SPAN. NOTCHES AT THE ENDS OF THE MEMBER SHALL NOT EXCEED ONE-FOURTH THE DEPTH OF THE MEMBER.
- 9. ROOF DECKING WITHIN 4' OF PARTI-LINE TO BE F.R. PLYWOOD WHERE THE RATED PARTIWALL EXTENDS LESS THAN 30" ABOVE NEW ROOF SURFACE

WEATHER BARRIERS AND FLASHINGS:

- 1. ENTIRE BUILDING ENVELOPE SHALL BE COVERED WITH AN APPROVED WEATHER BARRIER. THE BARRIER SHALL BE INSTALLED AS PER MANUFACTURER'S SPECIFICATION; ENSURE PROPER LAPPING OF MATERIAL
- 2. ALL WINDOW AND EXTERIOR DOOR ASSEMBLIES SHALL RECEIVE BOTH HEAD FLASHINGS AND SILL FLASHINGS AND OR SILL PANS. CONTRACTOR SHALL USE FLASHING MATERIALS THAT ARE COMPATIBLE WITH ADJACENT BUILDING MATERIALS. NOTE: APPLYING BUTYLE TAPE(S) AROUND THE PERIMETER OF DOOR AND WINDOW ASSEMBLIES DOES NOT QUALIFY AS INSTALLING FLASHING(S).
- 3. THE CONTRACTOR(S) SHALL INSURE THAT ALL WINDOW AND DOOR ASSEMBLIES ARE INSTALLED PER THE MANUFACTURERS INSTALLATION GUIDES AND RECOMMENDATIONS

EXTERIOR FINISHES:

1. ALL EXTERIOR FINISHES SHALL PROVIDE FOR DRAINAGE AT THE LOWEST POINT OF THE FINISH SYSTEM/ MATERIAL, INSURE PROPER LAPPING AND FLASHING(S) BETWEEN FINISH SYSTEM(S)

BATHROOMS:

- 1, CERAMIC TILE FLOOR(S) SET IN MASTIC ON 3/8" CEMENT BD, ON 3/4" PLY-WD, SUB FLR., FLASH PATCH CEMENT BD. SUBSTRATE FOR PROPER CERAMIC CONDITIONS PROVIDE GROUT SEALER(S)
- 2. ALL GYPSUM BD. USED IN TOILET ROOM LOCATION SHALL BE MIN. 1/2" MOISTURE RESISTANT GYP. BD. W/ ANTI-FUNGAL PAINT FINISH

ROOFING:

- 1. ROOF SHEATHING TO BE 5/8" EXTERIOR GRADE T&G PLYWOOD SHEATHING. HOLD SHEATHING 2" CLEAR AT VENTING LOCATIONS.
- 2 LOW PITCH ROOF SYSTEM(S) TO BE MODIFIED BITUMINOUS 3- PLY BUILT-UP ROOF SYSTEM W/ SEMI-GRANULAR CAP SHEET UNO. SYSTEM TO BE INSTALLED AS PER MANUFACTURERS RECOMMENDATIONS
- 3. PROVIDE ICE AND SNOW SHIELD'S MIN. 48" FROM ALL EAVES, ALL VALLEYS W/ MIN. 30" LAP FROM VALLEY, ALL
- 4. ROOF CONTRACTOR TO PROVIDE MIN. .04" ALUM. FLASHING AS INDICATED IN DETAILS AND AT ALL ROOF DECK AND VERTICAL SURFACES, VALLEYS, PENETRATIONS THRU ROOF/ DECK
- 5. ROOFING CONTRACTOR TO PROVIDE .04" PRE-FINISHED ALUM. COPING SYSTEM AS INDICATED. PROVIDE ALL ASSOCIATED HARDWARE AND COMPONENTS WITH NON CORROSIVE FASTENERS.

BUILDING CODE ANALYSIS

2018 INTERNATIONAL BUILDING CODE (IBC) 2018 INTERNATIONAL RESIDENTIAL CODE (IRC) 2018 INTERNATIONAL EXISTING BUILDING CODE (IEBC) 2018 INTERNATIONAL ENERGY CONSERVATION CODE (IECC)

BUILDING CODE SUMMARY

DESCRIPTION OF WORK

THE CONVERSION OF THE EXISTING A FRAME ROOF INTO A FRONT AND REAR DORMER ON AN EXISTING 3 STORY SINGLE FAMILY DWELLING.

FIRE PROTECTION & LIFE SAFETY SYSTEMS - Chapter 3 IRC

R313,2 ONE- AND TWO-FAMILY DWELLINGS AN AUTOMATIC RESIDENTIAL FIRE SPRINKLER SYSTEM SHALL NOT BE REQUIRED FOR ADDITIONS OR ALTERATIONS TO EXISTING BUILDINGS THAT ARE NOT ALREADY PROVIDED WITH AN AUTOMATIC RESIDENTIAL SPRINKLER SYSTEM.

BUILDING DESCRIPTION - Chapter 5 IBC

BUILDING: R-3 CONSTRUCTION: VB

FIRE RESISTIVE CONSTRUCTION - Chapter 7 IBC

SECTION 704 STRUCTURAL MEMBERS	N/A	N/A
SECTION 705 EXTERIOR WALLS	N/A	N/A
SECTION 711 HORIZONTAL ASSEMBLIES	N/A	N/A

RESIDENTIAL ENERGY EFFICIENCY - Chapter 4 IECC TABLE R402.1.2 CLIMATE ZONE 4 REQUIRED PROVIDED

WOOD FRAME WALLS	R-20 OR R-13+5CI	R-23
FLOOR	R-19	R-19
ROOF	R-49	R-49
GLAZED FENESTRATIONS	U-0.32 SHGC-0.40	U-0.15 SHGC-0.11

AMENDMENT







COVER SHEET

G-001

DANIELLE HARVEY


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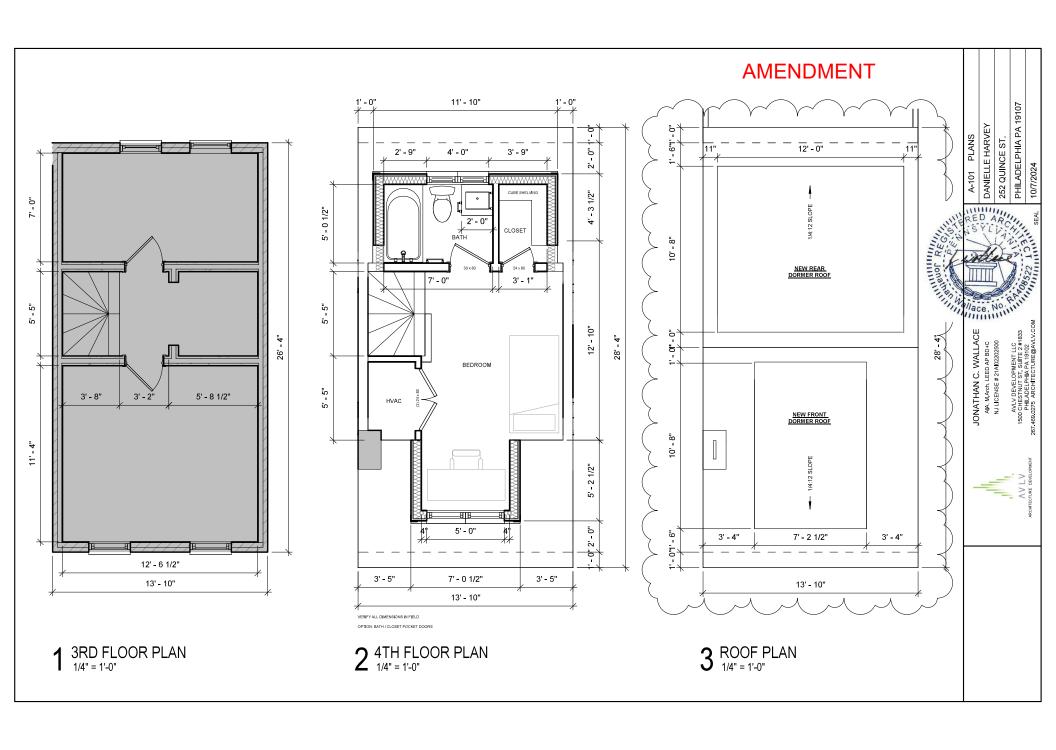



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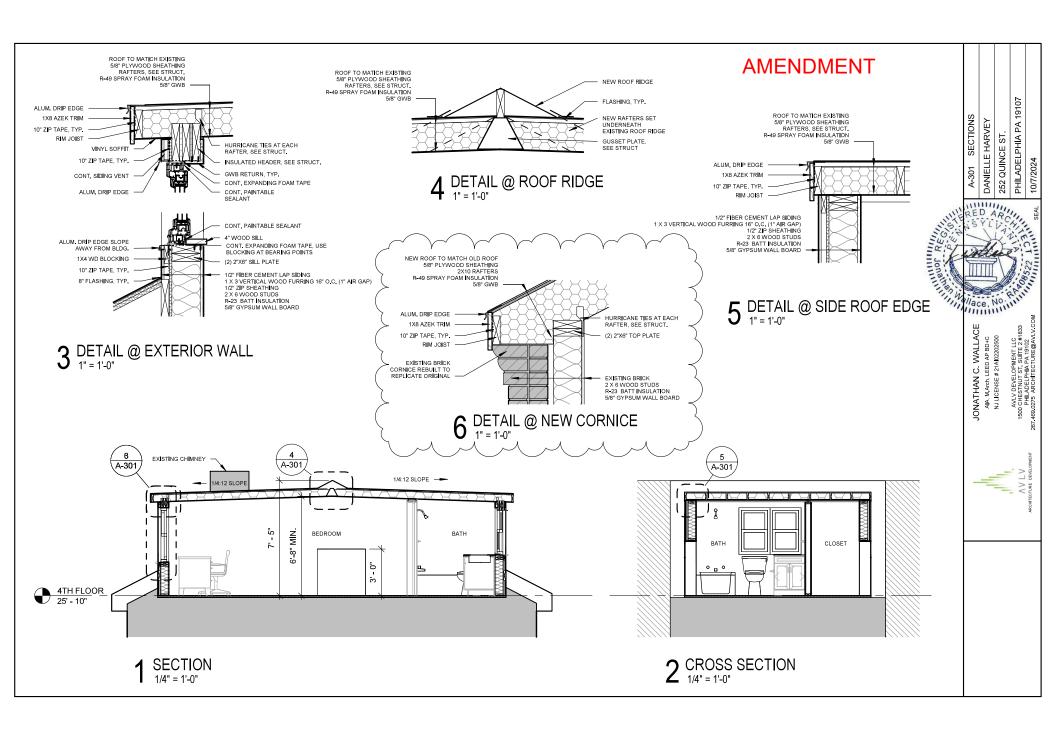
PHILADELPHIA PA

252 QUINCE ST.





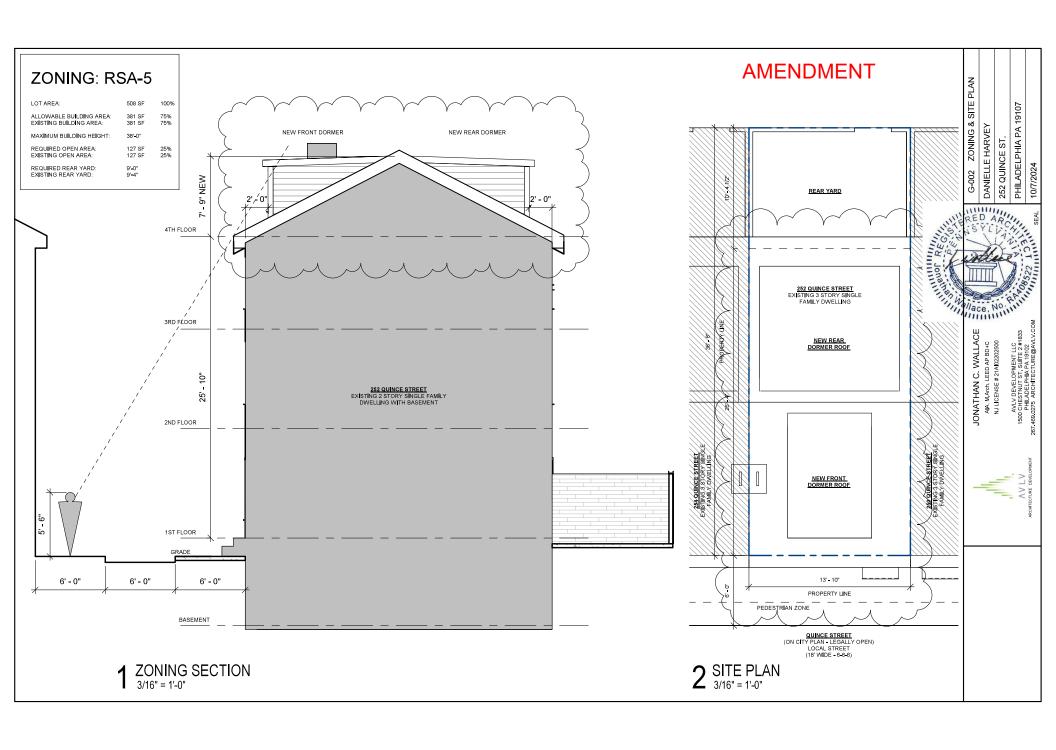

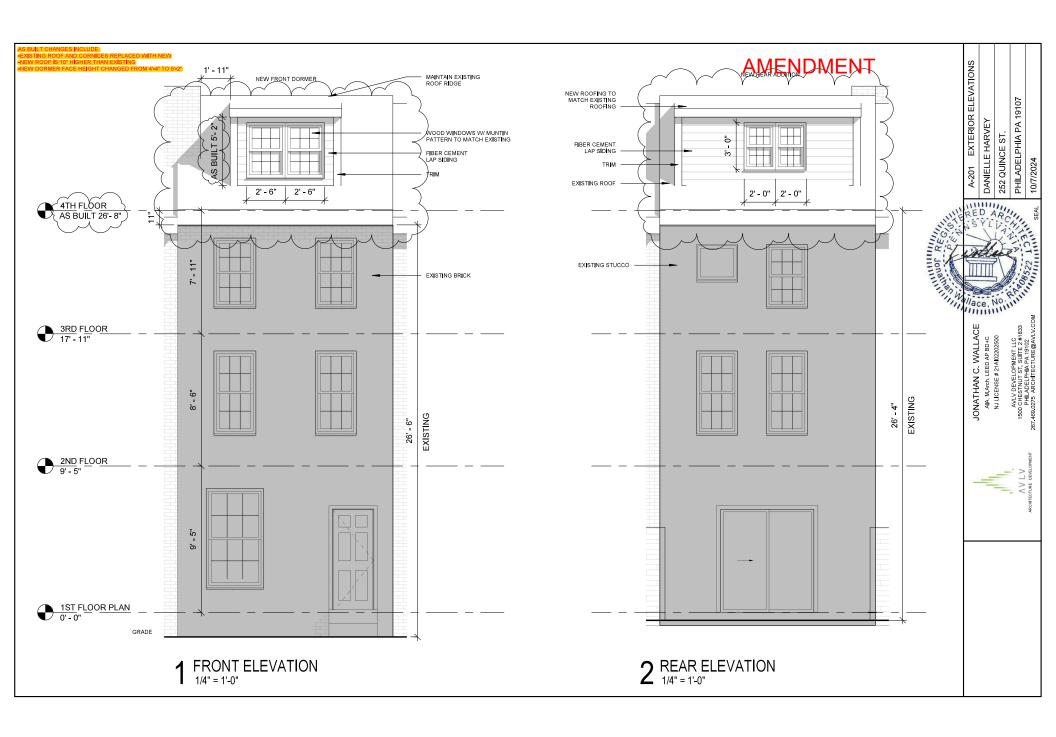

Plans approved by Historical Commission and Department of Licenses & Inspections

GENERAL FRAMING NOTES

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WOOD FRAMING WALLS & FLOOR NOTES:

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- 3. CONTRACTOR TO LAYOUT INTERIOR PARTITIONS & ALL ROUGH OPENINGS PRIOR TO ERECTING STUD WALLS TO COORDINATE DESIGN INTENT. NOTIFY ARCHITECT IMMEDIATELY UPON ANY DISCREPANCIES WITH ARCHITECTURAL FLOOR PLANS AND FIELD CONDITIONS. CONTRACTOR SHALL COORDINATE AND VERIFY CONDITIONS TO ENSURE PROPER FIT. CONTRACTOR IS RESPONSIBLE TO MAINTAIN CRITICAL DIMENSIONS AND
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- 6. ALL WOOD BEAMS / HEADERS OVER 6'-0" IN LENGTH TO BE GLUED AND BOLTED W/ 1/2" CARRIAGE BOLTS
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- 9. ROOF DECKING WITHIN 4' OF PARTI-LINE TO BE F.R. PLYWOOD WHERE THE RATED PARTIWALL EXTENDS LESS THAN 30" ABOVE NEW ROOF SURFACE

WEATHER BARRIERS AND FLASHINGS:

EXTERIOR FINISHES

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- 3. THE CONTRACTOR(S) SHALL INSURE THAT ALL WINDOW AND DOOR ASSEMBLIES ARE INSTALLED PER THE MANUFACTURERS INSTALLATION GUIDES AND RECOMMENDATIONS

1. ALL EXTER MATERIAL. I	XPLANS APPROVED		ST POINT OF THE FINISH SYSTEM SYSTEM(S)
BATHROOMS	AS NOTED FOR COMPLIANCE WITH PA UCC		
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2. ALL GYPSU FUNGAL PAIN	PDEPSERTMENTE OF PROFINSES & VALUE OF INNS 1/2	ľ	IOISTURE RESISTANT GYP. BD. W/ANTI-
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- HING TO BE 2/8" EX LEKIUK GRAVE 1849 PLYWOOD SHEAT HING. HOLD SHEATHING 2" CLEAR AT PA UCC CERT # 005638 2. LOW PIT T-UP ROOF SYSTEM W/ SEMI-GRANULAR
- COMMENDATIONS 3. PROVIDE ICE AND SNOW SHIELD'S MIN. 48" FROM ALL EAVES, ALL VALLEYS W/ MIN. 30" LAP FROM VALLEY, ALL
- 4. ROOF CONTRACTOR TO PROVIDE MIN. .04" ALUM. FLASHING AS INDICATED IN DETAILS AND AT ALL ROOF DECK AND VERTICAL SURFACES, VALLEYS, PENETRATIONS THRU ROOF/ DECK 5. ROOFING CONTRACTOR TO PROVIDE .04" PRE-FINISHED ALUM. COPING SYSTEM AS INDICATED. PROVIDE ALL ASSOCIATED HARDWARE AND COMPONENTS WITH NON CORROSIVE FASTENERS.

BUILDING CODE ANALYSIS

2018 INTERNATIONAL BUILDING CODE (IBC) 2015 INTERNATIONAL RESIDENTIAL CODE (IRC) 2018 INTERNATIONAL EXISTING BUILDING CODE (IEBC) 2018 INTERNATIONAL ENERGY CONSERVATION CODE (IECC)

BUILDING CODE SUMMARY

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R313.2 ONE- AND TWO-FAMILY DWELLINGS AN AUTOMATIC RESIDENTIAL FIRE SPRINKLER SYSTEM SHALL NOT BE REQUIRED FOR ADDITIONS OR ALTERATIONS TO EXISTING BUILDINGS THAT ARE NOT ALREADY PROVIDED WITH AN AUTOMATIC RESIDENTIAL SPRINKLER SYSTEM.

BUILDING DESCRIPTION - Chapter 5 IBC


BUILDING: R-3 CONSTRUCTION: VB

FIRE RESISTIVE CONSTRUCTION - Chapter 7 IBC

SECTION 704 STRUCTURAL MEMBERS	N/A	N/A	
SECTION 705 EXTERIOR WALLS	N/A	N/A	
SECTION 711 HORIZONTAL ASSEMBLIES	N/A	N/A	

RESIDENTIAL ENERGY EFFICIENCY - Chapter 4 IECC TABLE R402.1.2 CLIMATE ZONE 4 REQUIRED PROVIDED

WOOD FRAME WALLS	R-20 OR R-13+5CI	R-23
FLOOR	R-19	R-19
ROOF	R-49	R-49
GLAZED FENESTRATIONS	U-0.32 SHGC-0.40	U-0.15 SHGC-0.11

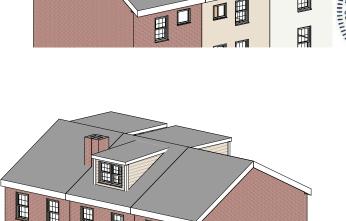





19107

PHILADELPHIA PA

252 QUINCE ST

COVER SHEET

G-001


DANIELLE HARVEY


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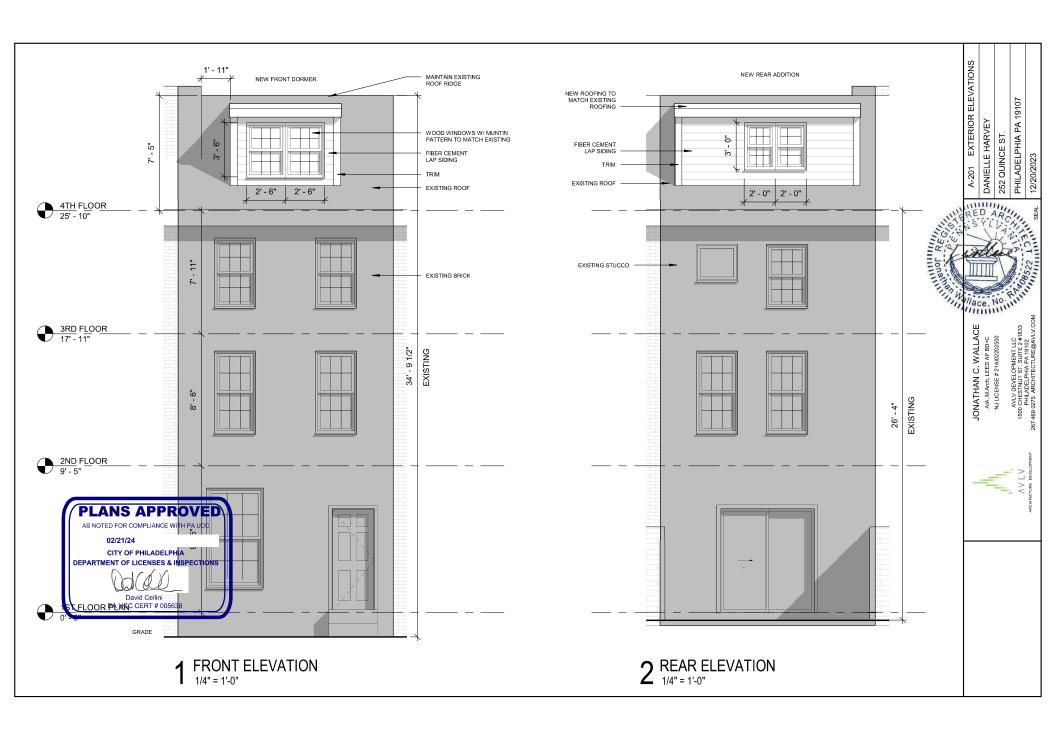
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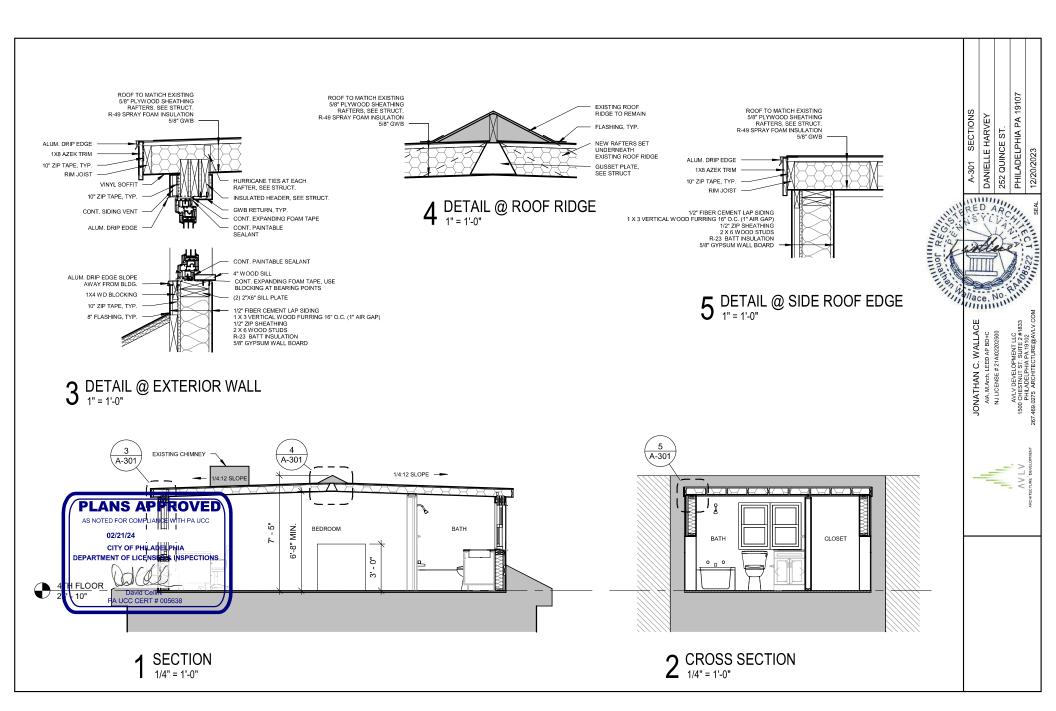
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GENERAL NOTES

- 1. THE WORK SHOWN ON THESE DRAWINGS HAS BEEN DESIGNED IN ACCORDANCE WITH THE STRUCTURAL REQUIREMENTS OF THE 2018 INTERNATIONAL RESIDENTIAL CODE (IRC) ADOPTED BY THE CITY OF PHILADELPHIA IN THE COMMONWEALTH OF PENNSYLVANIA.
- 2. THE STRUCTURAL COMPONENTS HAVE BEEN DESIGNED FOR THE FOLLOWING LIVE LOADS:

ROOF. GROUND SNOW LOAD OF 25 PSF

FLOOR:

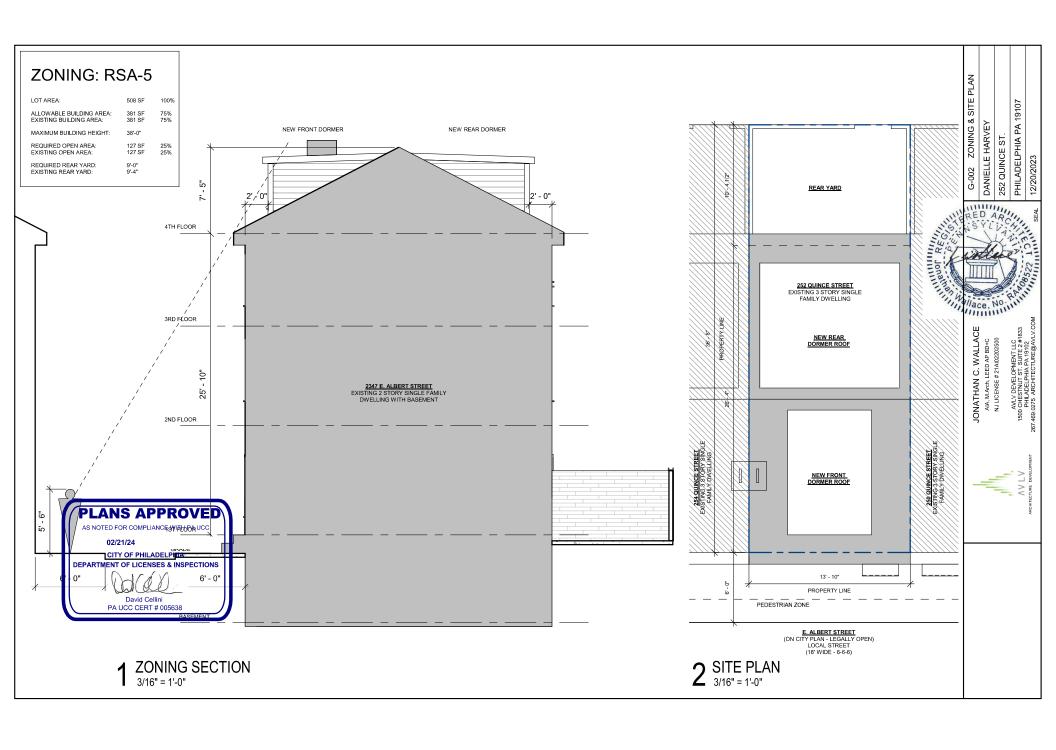WIND LOADS: 110 MPH BASIC WIND SPEED,

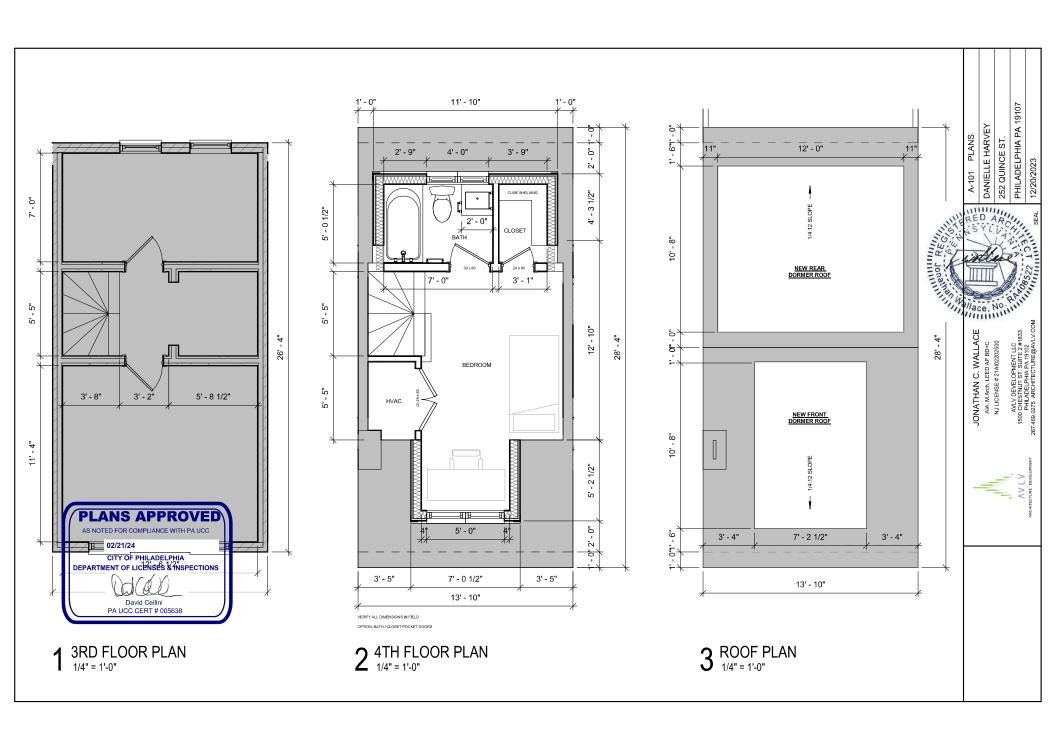WITH EXPOSURE B, I=1.

- 3. THE PORTIONS OF THE EXISTING STRUCTURE AFFECTED BY THIS WORK HAVE BEEN ANALYZED USING THE LOADS LISTED ABOVE AND FOUND TO BE CAPABLE OF SUPPORTING THE ADDITIONAL LOADS IMPOSED BY THIS WORK, EXCEPT WHERE STRENGTHENING WORK IS INDICATED ON THE PLANS.
- 4. THIS STRUCTURE HAS BEEN DESIGNED TO BE SELF- SUPPORTING AND STABLE AFTER THE CONSTRUCTION OF THE BUILDING HAS BEEN COMPLETED. THE STABILITY OF THE STRUCTURE PRIOR TO COMPLETION IS SOLELY THE RESPONSIBILITY OF THE CONTRACTOR. THIS RESPONSIBILITY EXTENDS TO ALL RELATED ASPECTS OF THE CONSTRUCTION ACTIVITY INCLUDING, BUT NOT LIMITED TO. ERECTION METHODS, ERECTION SEQUENCE, TEMPORARY BRACING, FORMS, SHORING, USE OF EQUIPMENT, AND SIMILAR CONSTRUCTION PROCEDURES. REVIEW OF THE CONSTRUCTION BY THE ENGINEER IS FOR CONFORMANCE WITH DESIGN ASPECTS ONLY, NOT TO REVIEW THE CONTRACTOR'S CONSTRUCTION PROCEDURES. LACK OF COMMENT ON THE PART OF THE ENGINEER WITH REGARD TO CONSTRUCTION PROCEDURES IS NOT TO BE INTERPRETED AS APPROVAL OF THOSE PROCEDURES.
- 5. JOBSITE SAFETY IS SOLELY THE RESPONSIBILITY OF THE CONTRACTOR. REVIEW OF THE CONSTRUCTION BY THE ENGINEER IS FOR CONFORMANCE WITH DESIGN ASPECTS ONLY, NOT TO REVIEW THE CONTRACTOR'S PROVISIONS FOR JOBSITE SAFETY. LACK OF COMMENT ON THE PART OF THE ENGINEER WITH REGARD TO JOBSITE SAFETY IS NOT TO BE INTERPRETED AS APPROVAL OF JOBSITE SAFETY ASPECTS.



TIMBER NOTES

- 1. DESIGN OF ALL WOOD FRAMING SHALL BE BASED UPON ALLOWABLE STRESS DESIGN, IN ACCORDANCE WITH THE NATIONAL DESIGN SPECIFICATION FOR WOOD CONSTRUCTION LATEST EDITION
- ALL WOOD FRAMING SHALL BE FABRICATED, ERECTED, AND BRACED IN ACCORDANCE WITH THE NATIONAL DESIGN SPECIFICATION FOR WOOD CONSTRUCTION, LATEST EDITION.
- ALL LUMBER SHALL HAVE GRADE IDENTIFIED ON THE LABLE OF AN APPROVED LUMBER
- GRADING AGENCY COMPLYING WITH DOC PS 20 OR EQUIVALENT. ALL SAWN LUMBER SHALL BE HEM-FIR #2, 19% MAXIMUM MOISTURE

CONTENT OR BETTER. THE MINIMUM DESIGN VALUES SHALL BE: Fb = 1000 nsi

Fv = 75 psiE = 1,300,000 psiFc - 1350 psi

MINIMUM DESIGN VALUES FOR PARALLAM MEMBERS SHALL BE:

Fb = 2900 psiFv = 290 psi

Fc = 2900 psiE = 2,000,000 psi

MINIMUM DESIGN VALUES FOR LVL MEMBER SHALL BE:

Fh = 2850 nsiFv = 285 psiFc = 2750 psiE = 2,000,000 psi

- 7. ALL STEEL TIMBER FASTENINGS AND JOIST HANGERS SHALL BE A MINIMUM OF 16 GA. GALVANIZED STEEL WITH A RATED LOAD CAPACITY FOUAL TO OR EXCEEDING THE IMPOSED LOADING REQUIREMENTS.
- ALL WOOD PLATES BEARING ON MASONRY OR CONCRETE WALLS SHALL BE PRESSURE TREATED LUMBER UNLESS NOTED OTHERWISE.
- ANCHOR ALL SILL PLATES TO CONCRETE OR MASONRY WALLS WITH A MINIMUM OF 1/2" ANCHOR BOLTS WITH 3" HOOK AND MINIMUM 7" EMBEDMENT SPACED AT 48 INCHES ON CENTER.
- PROVIDE SOLID BRIDGING OR A CONTINUOUS HEADER AT THE BEARING OF ROOF OR FLOOR JOISTS ON SILL PLATES.
- 11. PROVIDE DOUBLE JOISTS ON EACH SIDE OF ANY ROOF OR FLOOR JOIST WHICH IS INTERRUPTED BY AN OPENING OR OTHER CONSIDERATIONS. UNLESS OTHERWISE SHOWN ON PLANS, NO MORE THAN ONE ROOF OR FLOOR JOIST SHALL BE INTERRUPTED WITHOUT THE WRITTEN CONSENT OF THE ENGINEER.
- 12. PROVIDE A MINIMUM OF TWO POSTS TO SUPPORT ALL WOOD HEADERS. POST DEPTH SHALL MATCH WALL CONSTRUCTION.
- WOOD MEMBERS SHALL BE DESIGNED TO ACCOMMODATE AND SUPPORT MECHANICAL UNITS AS SHOWN ON THE MECHANICAL DRAWINGS.
- ALL WOOD FRAMING BEARING ON A PARTY WALL SHALL BE STAGGERED A MINIMUM DISTANCE OF 8" WITH FRAMING BEARING ON OPPOSITE SIDE OF WALL
- 15. PLYWOOD/ROOF SHEATHING SHALL CONFORM TO DOC PS 1
- ALL DOUBLE JOISTS SHALL BE SPIKED TOGETHER WITH 2 ROWS OF 10d NAILS @ 16" O.C.
- 17. ALL WOOD BEAMS MADE UP OF 3 OR MORE MEMBERS SHALL BE BOLTED TOGETHER WITH 1/2" BOLTS @ 16" o.c. STAGGERED TOP AND BOTTOM
- ALL PLYWOOD SHALL MEET THE REQUIREMENTS OF THE PLYWOOD DESIGN SPECIFICATIONS AS PUBLISHED BY THE AMERICAN INSTITUTE OF TIMBER CONSTRUCTION, LATEST EDITION.
- 19. PLYWOOD SHEATHING SHALL BE CONTINUOUS OVER A MINIMUM OF 3
- PLYWOOD SHALL BE SECURELY FASTENED 3/8" FROM THE EDGE, NOT MORE THAN 6 INCHES ON CENTER AT ALL EDGES, AND NOT MORE THAN 12 INCHES ON CENTER FOR ALL INTERMEDIATE JOISTS. USE 8d NAILS FOR 5/8" PLYWOOD.



SITE MAP

NTS

APPROVED

January 31, 2024

PHILADELPHIA HISTORICAL COMMISSION

LAURA DIPASQUALE

LAURA DIPASQUALE



PROJECT LOCATION 252 QUINCE ST PHILADELPHIA, PA 19107

3-STORY SINGLE BUILDING ALTERATION




NOTES

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SCALE: AS NOTED DATE: 12/19/2023 PRO JECT NO. 4652023 DRAWING NO

1 OF 7

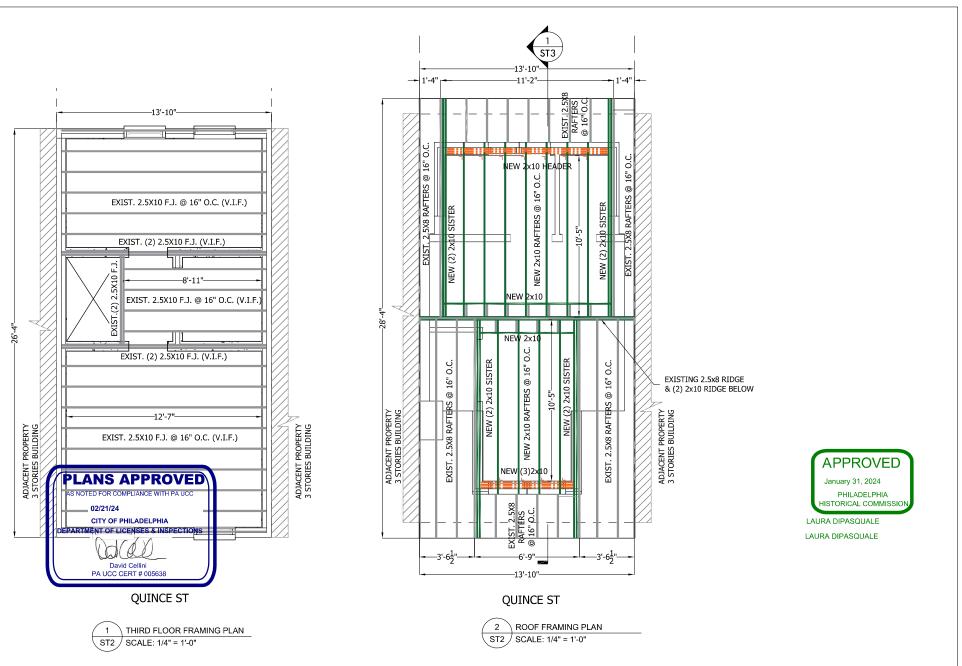

GLENWOOD ENGINEERING



PROJECT LOCATION 252 QUINCE ST, PHILADELPHIA, PA 19107

3-STORY SINGLE BUILDING ALTERATION PLAN

DRAWING TITLE

FRAMING PLANS


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PROJECT NO. 4652023

DRAWING NO.

SHEET NO. 2 OF 7





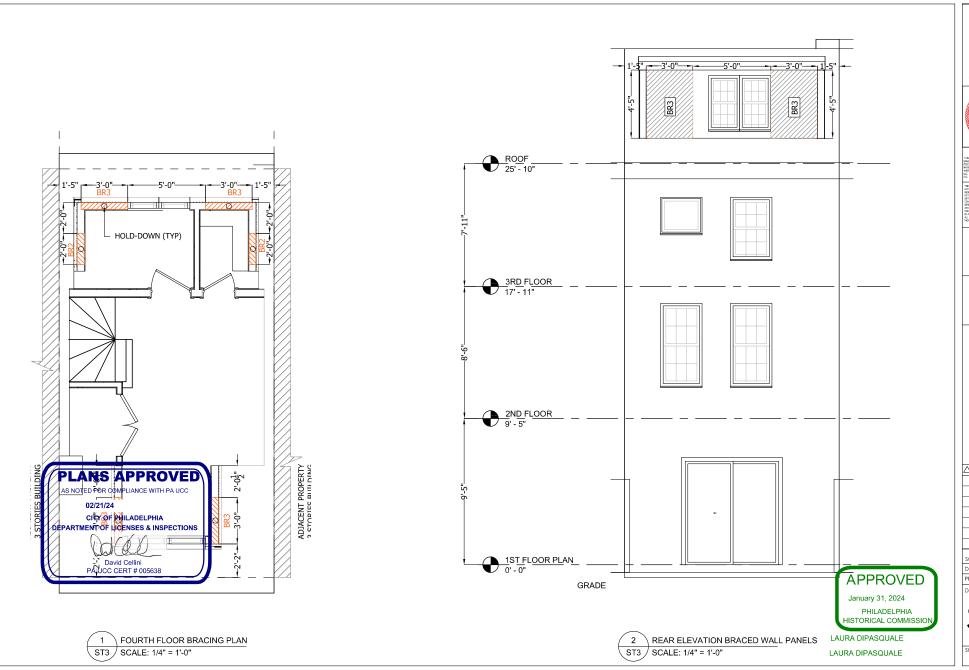

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PA 19107

3-STORY SINGLE BUILDING ALTERATION PLAN

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WALL BRACING

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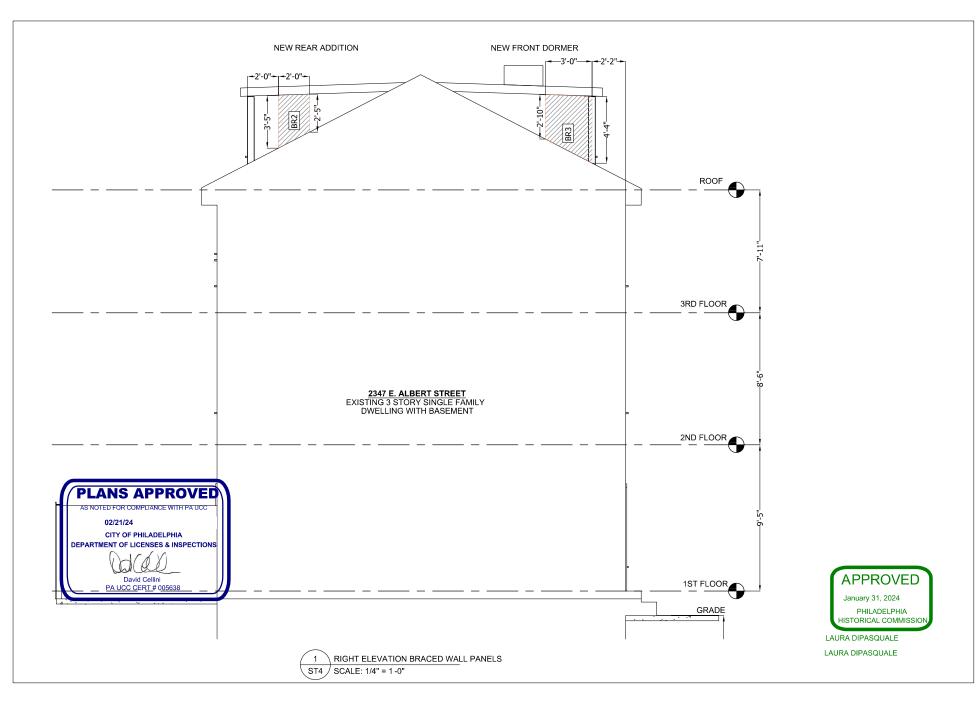
DATE : 12/19/2023

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DRAWING NO.

ST-3

SHEET NO. 3 OF 7







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3-STORY SINGLE BUILDING ALTERATION PLAN

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WALL BRACING

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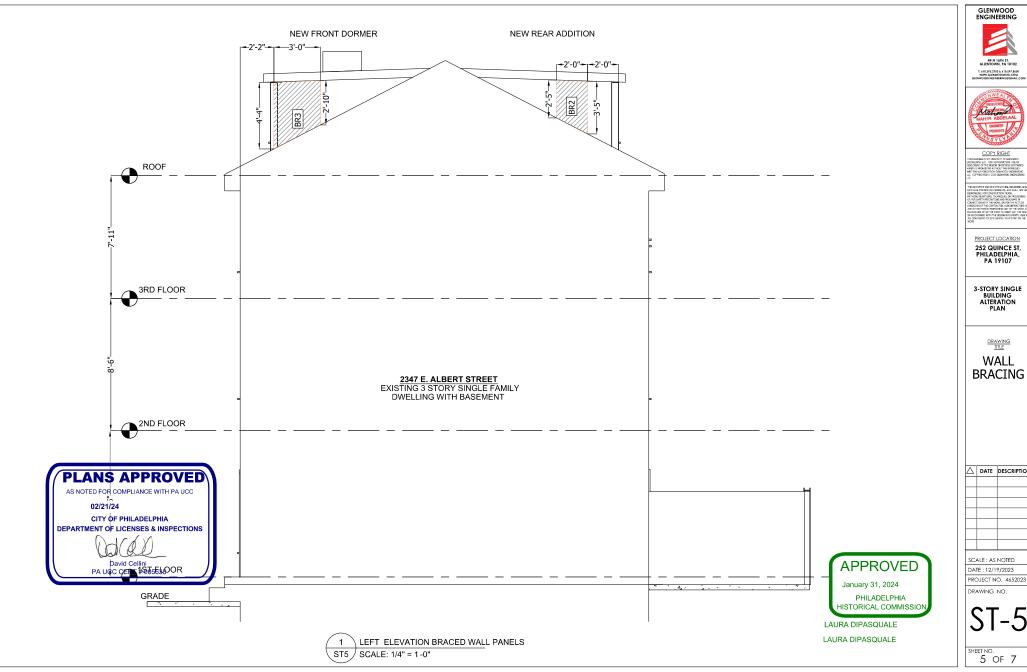
DATE: 12/19/2023

PROJECT NO. 4652023

DRAWING NO.

ST-4

SHEET NO. 4 OF 7







PROJECT LOCATION 252 QUINCE ST, PHILADELPHIA, PA 19107

3-STORY SINGLE BUILDING ALTERATION PLAN

DRAWING TITLE WALL

Δ	DATE	DESCRIPTION

SCALE : AS NOTED DATE: 12/19/2023 PROJECT NO. 4652023 DRAWING NO.

SHEET NO. 5 OF 7

